

DEVELOPMENT APPLICATION PDPLANPMTD-2024/041793

PROPOSAL: Three Multiple Dwellings

LOCATION: 18 & 20 Kotona Street, Rokeby

RELEVANT PLANNING SCHEME: Tasmanian Planning Scheme - Clarence

ADVERTISING EXPIRY DATE: 05 April 2024

The relevant plans and documents can be inspected at the Council offices, 38 Bligh Street, Rosny Park, during normal office hours until 05 April 2024. In addition to legislative requirements, plans and documents can also be viewed at www.ccc.tas.gov.au during these times.

Any person may make representations about the application to the Chief Executive Officer, by writing to PO Box 96, Rosny Park, 7018 or by electronic mail to clarence@ccc.tas.gov.au. Representations must be received by Council on or before 05 April 2024.

To enable Council to contact you if necessary, would you please also include a day time contact number in any correspondence you may forward.

Any personal information submitted is covered by Council's privacy policy, available at www.ccc.tas.gov.au or at the Council offices.

Clarence City Council



APPLICATION FOR DEVELOPMENT / USE OR SUBDIVISION

The personal information on this form is required by Council for the development of land under the Land Use Planning and Approvals Act 1993. We will only use your personal information for this and other related purposes. If this information is not provided, we may not be able to deal with this matter. You may access and/or amend your personal information at any time. How we use this information is explained in our **Privacy Policy**, which is available at www.ccc.tas.gov.au or at Council offices.

Proposal:	Multiple dwellings x3
Location:	Address 18 & 20 Kotona St Suburb/Town Rokeby Postcode 7019
Current Owners/s: Applicant:	Personal Information Removed
Tax Invoice for application fees to be in the name of: (if different from applicant)	
	Estimated cost of development \$ 1.1 million
	Is the property on the Tasmanian Heritage Register? Yes No X
	(if yes, we recommend you discuss your proposal with Heritage Tasmania prior to lodgement as exemptions may apply which may save you time on your proposal)

38 Bligh Street, Rosny Park, Tasmania • Address correspondence to: General Manager, PO Box 96, Rosny Park 7018 • Dx: 70402 Telephone (03) 6217 9550 • Email cityplanning@ccc.tas.gov.au • Website www.ccc.tas.gov.au

	If you had pre-application discussions with a Council Officer, please give their name	
	Current Use of Site: Vacantland	
	Does the proposal involve land administered or owned by the Crown or Council?	
Declaration:	I have read the Certificate of Title and Schedule of Easements for the land and am satisfied that this application is not prevented by any restrictions, easements or covenants. I authorise the provision of a copy of any documents relating to this application to any person for the purposes of assessment or public consultation. I agree to arrange for the permission of the copyright owner of any part of this application to be obtained. I have arranged permission for Council's representatives to enter the land to assess this application I declare that, in accordance with Section 52 of the Land Use Planning and Approvals Act 1993, that I have notified the owner of the intention to make this application. Where the subject property is owned or controlled by Council or the Crown, their signed consent is attached. Where the application is submitted under Section 43A, the owner's consent is attached. I declare that the information in this declaration is true and correct.	
Acknowledgement	■ I acknowledge that the documentation submitted in support of my application will become a public record held by Council and may be reproduced by Council in both electronic and hard copy format in order to facilitate the assessment process; for display purposes during public consultation; and to fulfil its statutory obligations. I further acknowledge that following determination of my application, Council will store documentation relating to my application in electronic format only.	
Applicant's Signature:	25/01/2024 Date	

PLEASE REFER TO THE DEVELOPMENT/USE AND SUBDIVISION CHECKLIST ON THE FOLLOWING PAGES TO DETERMINE WHAT DOCUMENTATION MUST BE SUBMITTED WITH YOUR APPLICATION.



RESULT OF SEARCH

RECORDER OF TITLES

Issued Pursuant to the Land Titles Act 1980



SEARCH OF TORRENS TITLE

VOLUME	FOLIO
184319	70
EDITION 2	DATE OF ISSUE 28-Aug-2023

SEARCH DATE : 27-Feb-2024 SEARCH TIME : 11.48 AM

DESCRIPTION OF LAND

City of CLARENCE

Lot 70 on Sealed Plan 184319

Derivation: Part of Lot 37617 (56.81ha) Gtd. to The

Director-General of Housing & Construction

Prior CT 142549/1

SCHEDULE 1

N137164 TRANSFER to S & D PROPERTY CO PTY LTD Registered 28-Aug-2023 at 12.05 PM

SCHEDULE 2

Reservations and conditions in the Crown Grant if any

SP184319 EASEMENTS in Schedule of Easements

SP184319 COVENANTS in Schedule of Easements

SP184319 FENCING PROVISION in Schedule of Easements

SP142549 COVENANTS in Schedule of Easements

SP142549 FENCING COVENANT in Schedule of Easements

SP142549 WATER SUPPLY RESTRICTION

SP142549 SEWERAGE AND/OR DRAINAGE RESTRICTION

E356704 MORTGAGE to National Australia Bank Limited

Registered 28-Aug-2023 at 12.08 PM

UNREGISTERED DEALINGS AND NOTATIONS

No unregistered dealings or other notations

Page 1 of 1



RESULT OF SEARCH

RECORDER OF TITLES

Issued Pursuant to the Land Titles Act 1980



SEARCH OF TORRENS TITLE

VOLUME	FOLIO
184319	69
EDITION 2	DATE OF ISSUE 28-Aug-2023

SEARCH DATE : 27-Feb-2024 SEARCH TIME : 11.48 AM

DESCRIPTION OF LAND

City of CLARENCE

Lot 69 on Sealed Plan 184319

Derivation: Part of Lot 37617 (56.81ha) Gtd. to The

Director-General of Housing & Construction

Prior CT 142549/1

SCHEDULE 1

N137164 TRANSFER to S & D PROPERTY CO PTY LTD Registered 28-Aug-2023 at 12.05 PM

SCHEDULE 2

Reservations and conditions in the Crown Grant if any

SP184319 EASEMENTS in Schedule of Easements

SP184319 COVENANTS in Schedule of Easements

SP184319 FENCING PROVISION in Schedule of Easements

SP142549 COVENANTS in Schedule of Easements

SP142549 FENCING COVENANT in Schedule of Easements

SP142549 WATER SUPPLY RESTRICTION

SP142549 SEWERAGE AND/OR DRAINAGE RESTRICTION

E356703 MORTGAGE to National Australia Bank Limited

Registered 28-Aug-2023 at 12.07 PM

UNREGISTERED DEALINGS AND NOTATIONS

No unregistered dealings or other notations


Page 1 of 1



RECORDER OF TITLES



Issued Pursuant to the Land Titles Act 1980

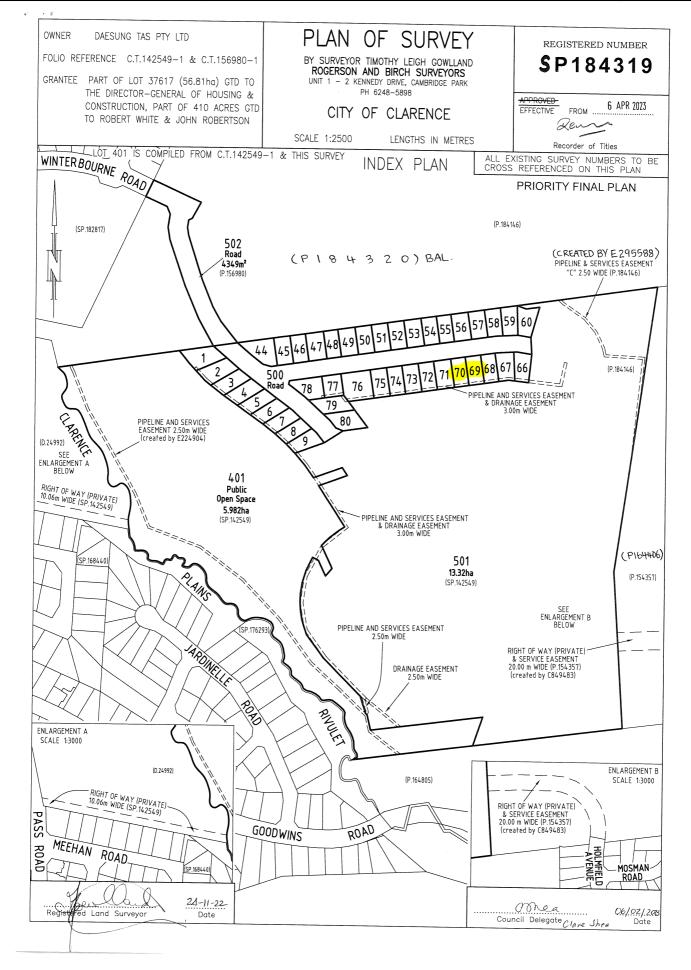


Search Date: 23 Aug 2023 Search Time: 10:22 AM Volume Number: 184319 Revision Number: 01 Page 1 of 7



RECORDER OF TITLES



Issued Pursuant to the Land Titles Act 1980

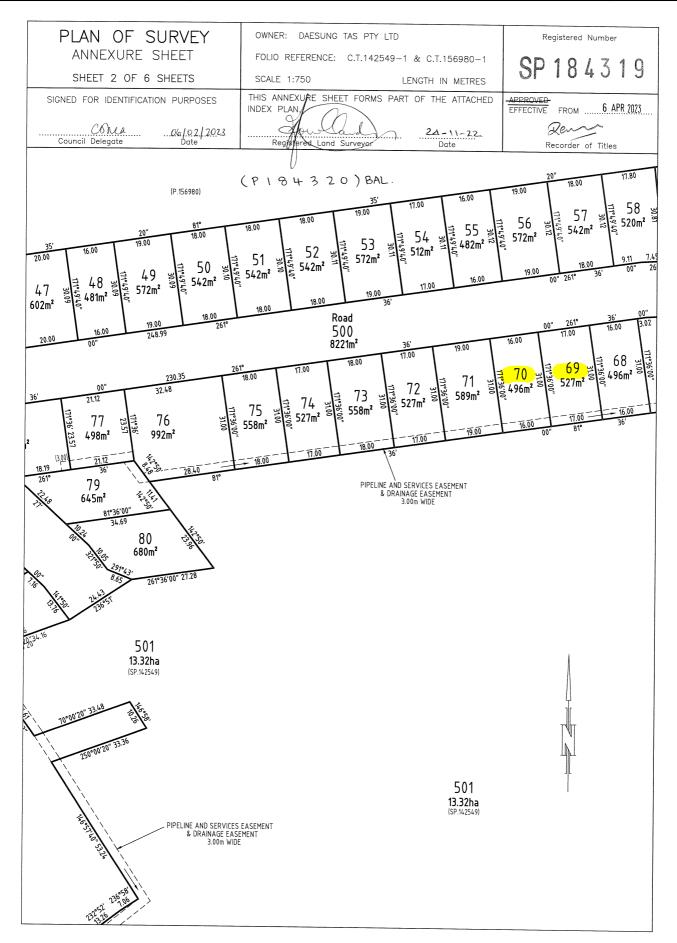


Search Date: 23 Aug 2023 Search Time: 10:22 AM Volume Number: 184319 Revision Number: 01 Page 3 of 7



RECORDER OF TITLES



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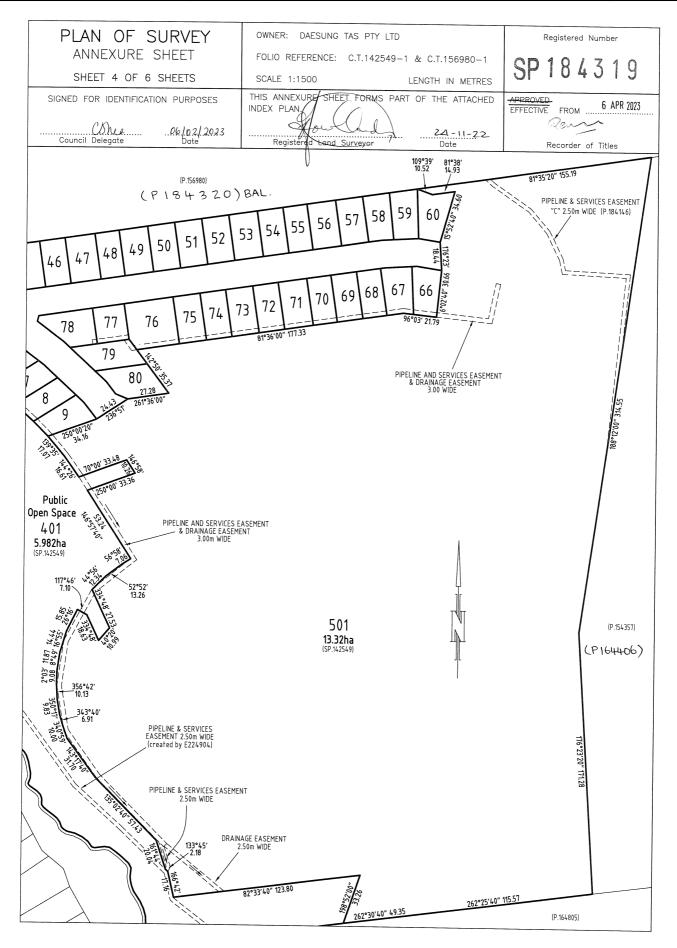
Search Date: 23 Aug 2023 Search Time: 10:22 AM Volume Number: 184319 Revision Number: 01 Page 4 of 7

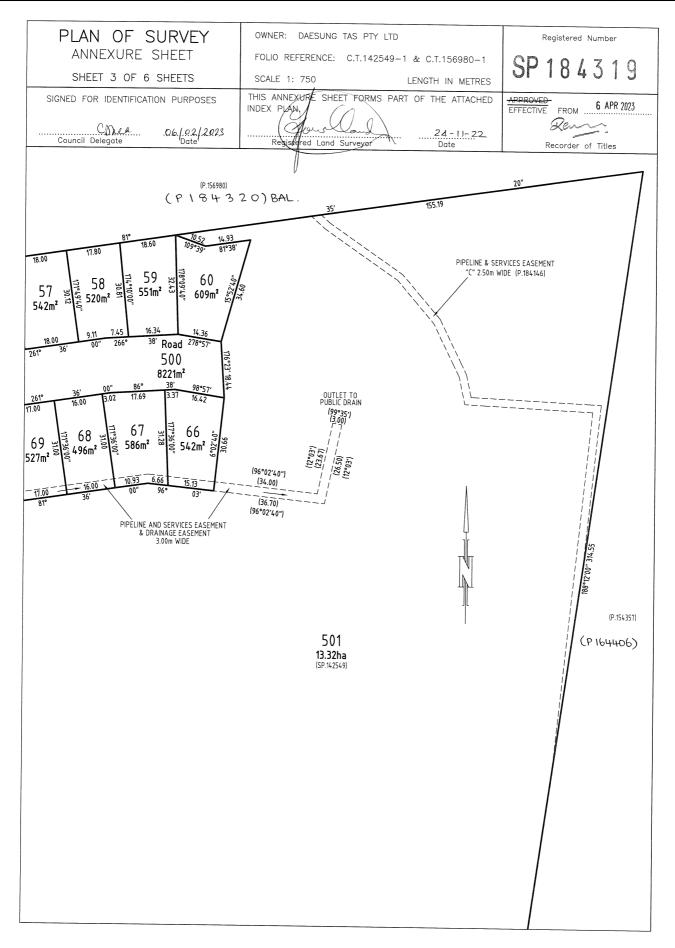

RECORDER OF TITLES



Issued Pursuant to the Land Titles Act 1980




Search Date: 23 Aug 2023 Search Time: 10:22 AM Volume Number: 184319 Revision Number: 01 Page 5 of 7



RECORDER OF TITLES



Issued Pursuant to the Land Titles Act 1980

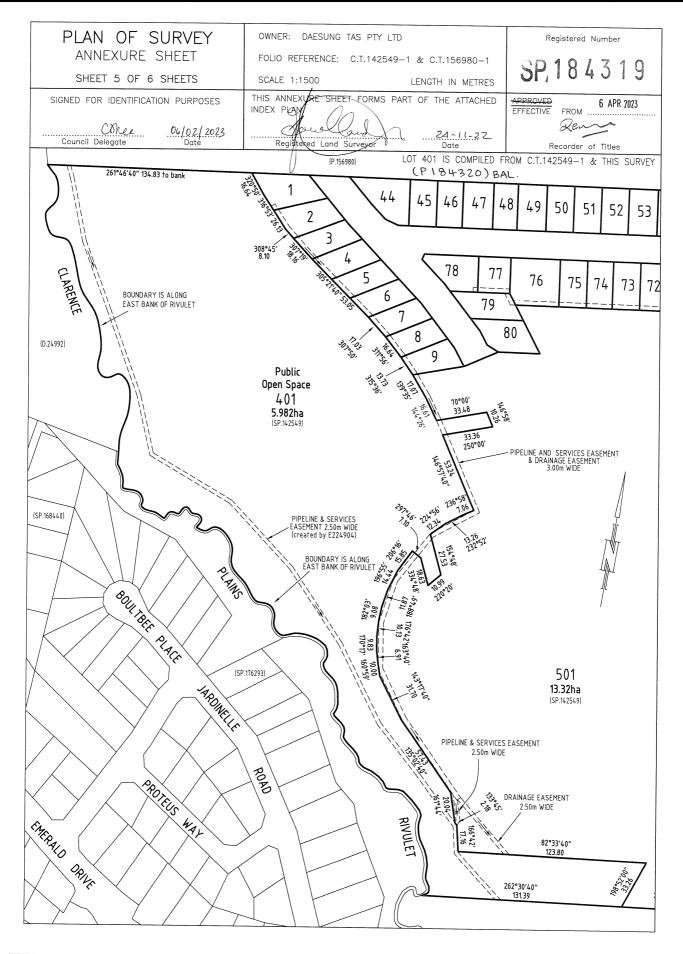

Search Date: 23 Aug 2023

Search Time: 10:22 AM

Volume Number: 184319

Revision Number: 01


Page 6 of 7



RECORDER OF TITLES



Issued Pursuant to the Land Titles Act 1980

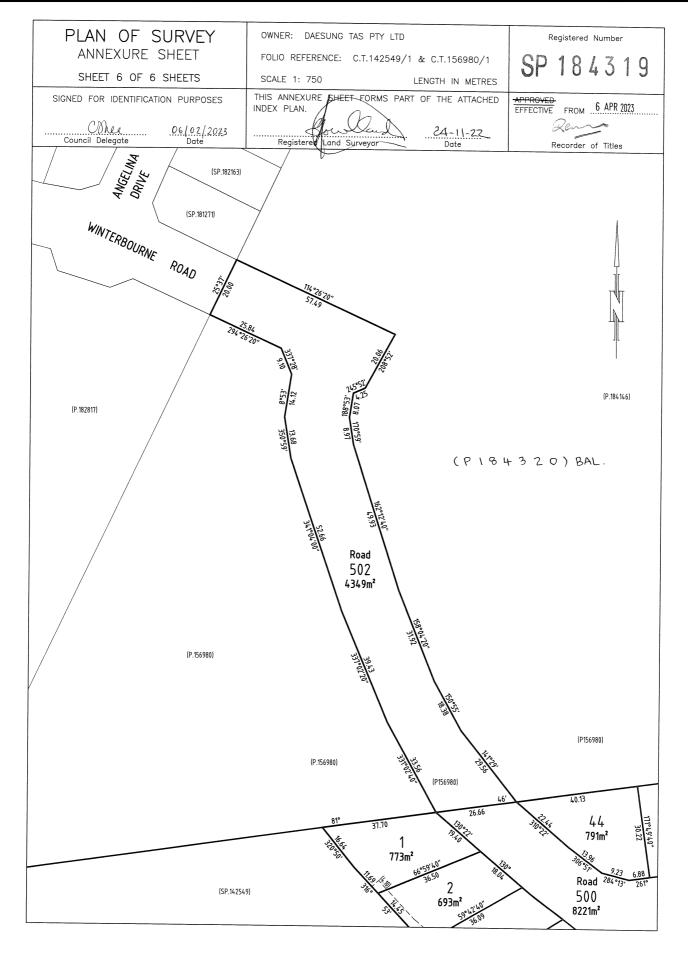

Search Date: 23 Aug 2023 Search Time: 10:22 AM Volume Number: 184319 Revision Number: 01 Page 7 of 7

PINNACLE







18 & 20 Kotona St, Rokeby 7019

Owner(s) or Clients

S & D Property Co Pty Ltd

Building Classification

3 x 1a

Designer

Jason Nickerson CC6073Y

Total Floor Area (Combined)

390.54m²

Patio 75.44m²

Alpine Area

N/A


Other Hazards


Safeguarding of Airports, Bushfire-Prone Areas, Paranville Specific Area Plan

Title Reference 184319/69 & 70 General Residential Zoning 1023m² Land Size Design Wind Speed TBA Soil Classification TBA Climate Zone 7 Corrosion Environment Low Bushfire Attack Level (BAL) 12.5

ID	Sheet Name	Issue
A0.01	Location Plan	DA - 03
A0.02	Site Plan	DA - 03
A0.03	Site Elevations	DA - 03
A0.04	Shadow Diagrams, 21st June	DA - 03
A1.01	U1 - Floor Plan	DA - 03
A1.02	U1 - Elevations	DA - 03
A1.03	U1 - Elevations	DA - 03
A1.04	U1 - Roof Plan	DA - 03
A1.05	U1 - Electrical Plan	DA - 03
A2.01	U2 - Floor Plan	DA - 03
A2.02	U2 - Elevations	DA - 03
A2.03	U2 - Elevations	DA - 03
A2.04	U2 - Roof Plan	DA - 03
A2.05	U2 - Electrical Plan	DA - 03
A2.01	U3 - Floor Plan	DA - 03
A2.02	U3 - Elevations	DA - 03
A2.03	U3 - Elevations	DA - 03
A2.04	U3 - Roof Plan	DA - 03
A2.05	U3 - Electrical Plan	DA - 03
C.01	Civil Plan	DA - 03
C.02	Parking	DA - 03
C.03	Parking	DA - 03
L.01	Landscaping Plan	DA - 03
L.02	Planting Schedule & Details	DA - 03
P.01	Sewer & Water Plan	DA - 03

Document Set ID: 5210465 Version: 1, Version Date: 04/03/2024

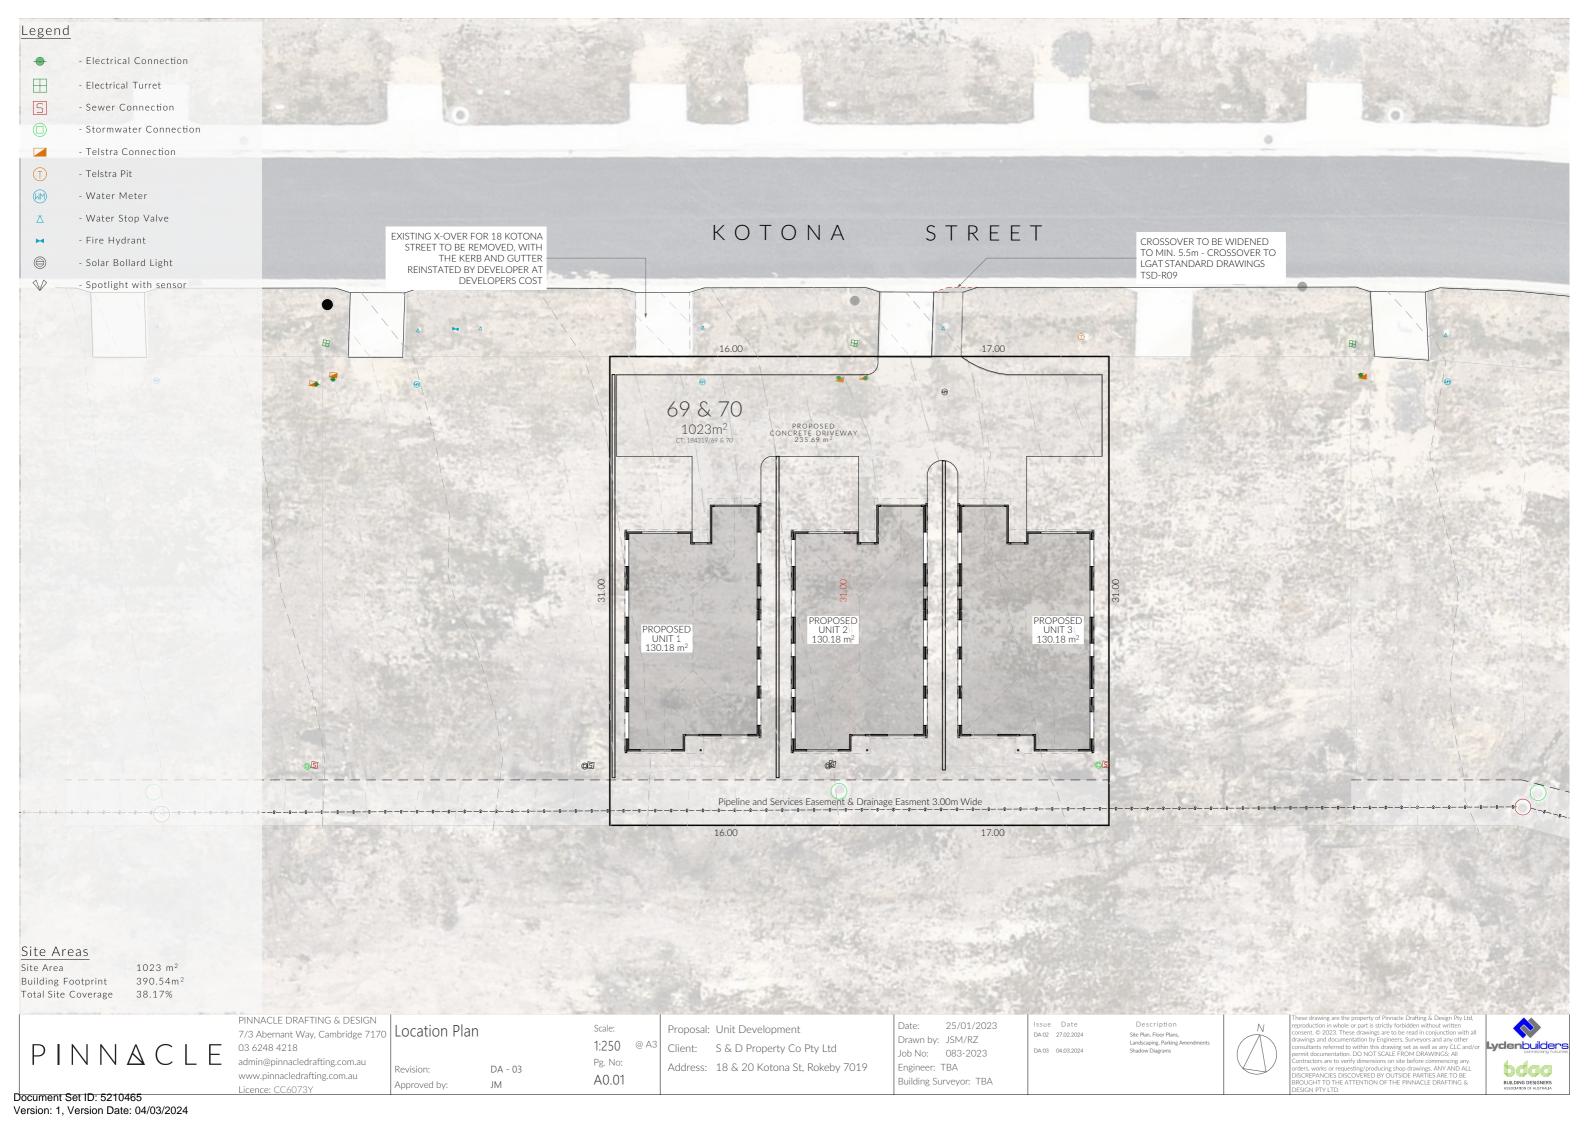

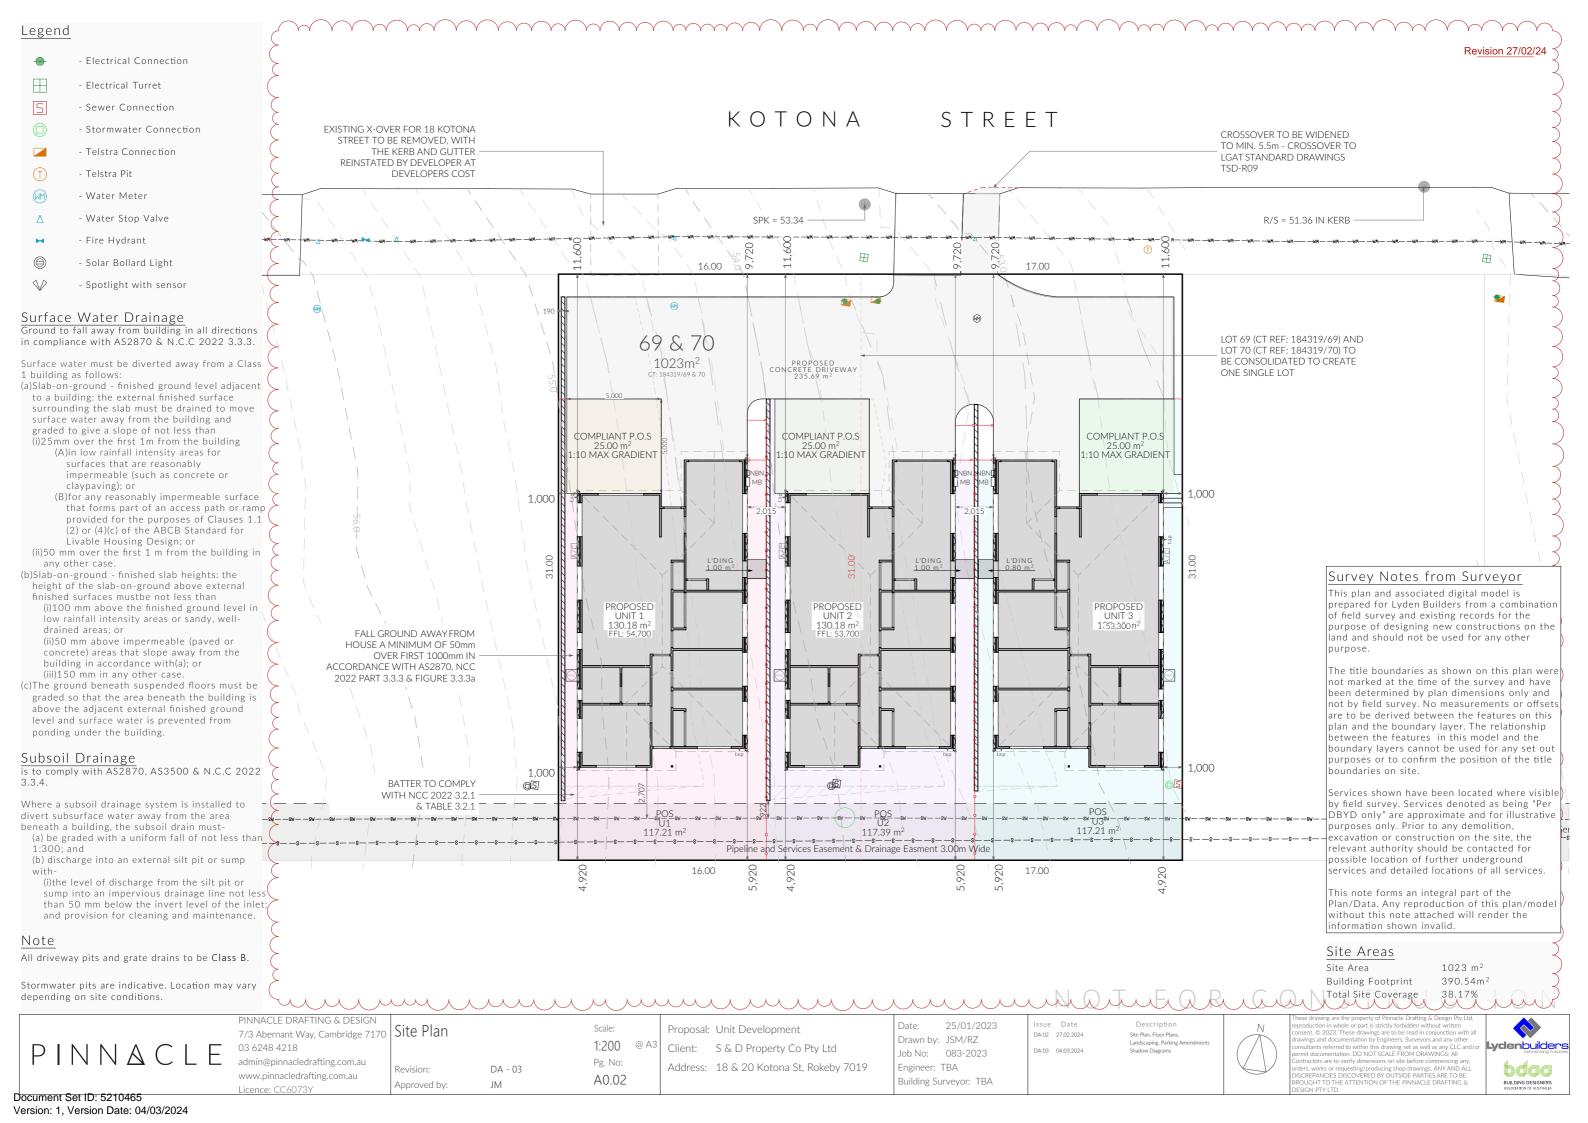



Site Elevation - North Elevation





Site Elevation - South Elevation Clearances between cladding and ground shall comply with Clause 7.5.7 of the NCC 2022 and shall be a minimum clearance of: 100mm in low rainfall intensity areas or sandy, well-drained areas; or 50mm above impermeable areas that slope away from the building; or 150mm in any other case.

1:100

Wall cladding must extend a minimum of 50 mm below the bearer or lowest horizontal part of the suspended floor framing.

U.N.O in builders specifications or located in saline environments or if using a glazed finish brick, brickwork is to be installed in stretcher bond pattern with raked joints.

Openable windows greater than 4m above ground level are to be fitted with a device to limit the opening or a suitable screen so a 125mm sphere cannot pass through, and withstand a force of 250N. Except for bedrooms, where the requirement is for heights above 2m.

Revision:

Approved by:

All stairs to be constructed in accordance with NCC 2022 Vol II Part 11.2.2 Riser: Min 115mm - Max 190mm

Going: Min 240mm - Max 355mm PINNACLE DRAFTING & DESIGN 7/3 Abernant Way, Cambridge 7170 PINNACLE 03 6248 4218 admin@pinnacledrafting.com.au

www.pinnacledrafting.com.au

Licence: CC6073Y

Slope (2R+G): Max 550 - Min 700 Site Elevations

DA - 03

JM

Scale:

Pg. No:

A0.03

1:100 @ A3

Proposal: Unit Development Client: S & D Property Co Pty Ltd

Address: 18 & 20 Kotona St, Rokeby 7019

25/01/2023 Drawn by: JSM/RZ Job No: 083-2023 Engineer: TBA


Building Surveyor: TBA


DA 02 27.02.2024 DA 03 04.03.2024


Description Site Plan, Floor Plans, Landscaping, Parking Amendment




Document Set ID: 5210465 Version: 1, Version Date: 04/03/2024

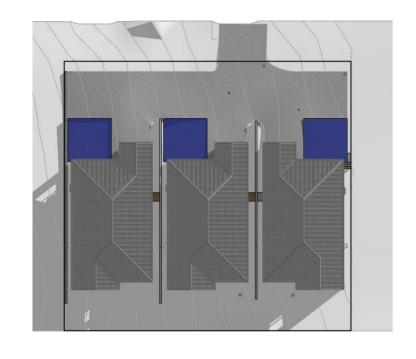


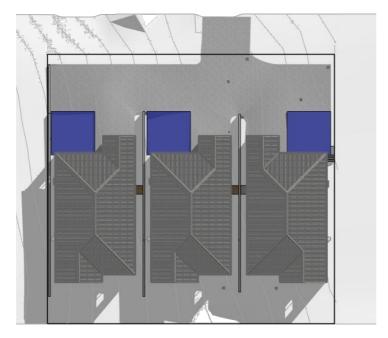


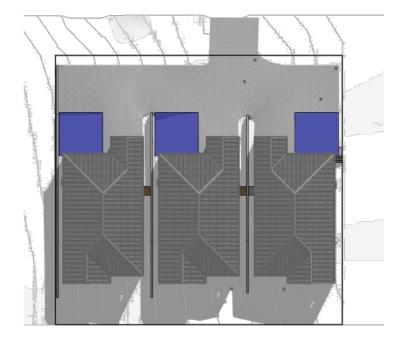


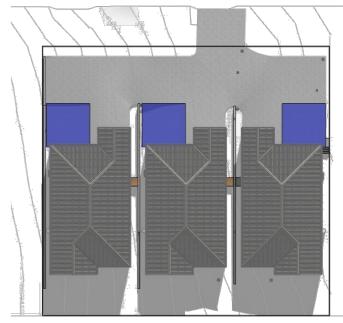

9 a m 10 a m 11am 12 p m

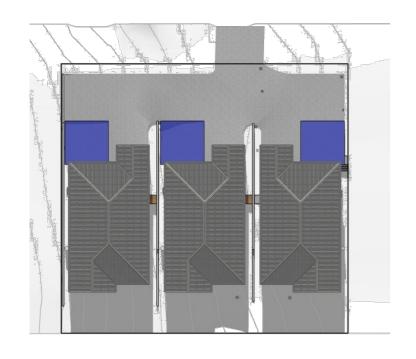

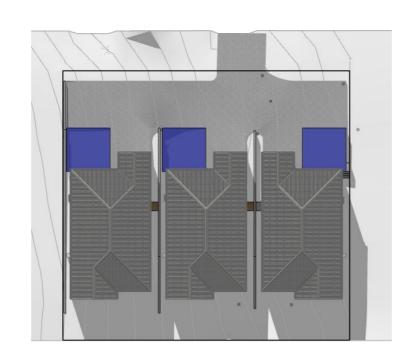

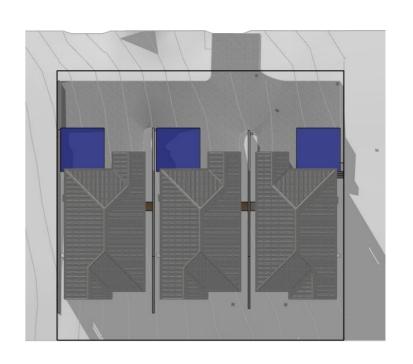

3 p m 2 p m 1 p m

PINNACLE

PINNACLE DRAFTING & DESIGN 7/3 Abernant Way, Cambridge 7170 Shadow Diagrams, 21st June 03 6248 4218

admin@pinnacledrafting.com.au www.pinnacledrafting.com.au Licence: CC6073Y

Approved by:

DA - 03

JM

Scale: Pg. No: A0.04


Proposal: Unit Development @ A3 | Client: S & D Property Co Pty Ltd

Address: 18 & 20 Kotona St, Rokeby 7019

25/01/2023 Drawn by: JSM/RZ Job No: 083-2023 Engineer: TBA Building Surveyor: TBA

Issue Date DA 02 27.02.2024 DA 03 04.03.2024 Description
Site Plan, Floor Plans,
Landscaping, Parking Amendments
Shadow Diagrams



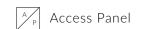

Articulation Joint

(SA) Smoke Alarm

Construction of sanitary

compartments 10.4.2 of NCC 2022

The door to a fully enclosed sanitary compartment must -

- open outwards; or
- be readily removable from the outside of the compartment.

unless there is a clear space of at least 1.2 m, measured in accordance with Figure 10.4.2 of NCC 2022 Vol II, between the closet pan within the sanitary compartment and the doorway.

Note: Safe Movement & Egress

Openable windows greater than 4m above the opening or a suitable screen so a 125mm sphere information on suitable protective devices.

Note: Paved Areas

All stairs to be constructed in accordance with NCC

Riser: Min 115mm - Max 190mm

Slope (2R+G): Max 550 - Min 700

infrequently, refer to table 11.2.2(b).

minimum of 750mm deep measured 500mm from the inside edge of the landing.

comply with Clause 11.2.4.

Heights of rooms & other spaces

(c)in a corridor, passageway or the like - 2.1 m; and

(d)in a bathroom, shower room, laundry, sanitary parking area or the like - 2.1 m; and

(e)in a room or space with a sloping ceiling or projections below the ceiling line within- See NCC

measured vertically above the nosing line of stairway treads or the floor surface of a ramp,

If required onsite, the builder may work within the tolerances of the above as specified within the NCC 2022 Vol II. Builder to contact Pinnacle before

Floor Areas

Total Floor Area

PINNACLE 03 6248 4218

Revision:

Approved by:

DA - 03 JM

009

90 /

1,000 4

* °

Proposal: Unit Development Client: S & D Property Co Pty Ltd

25/01/2023 Drawn by: JSM/RZ Job No: 083-2023 Engineer: TBA

Building Surveyor: TBA

250

250

CONC. L'DING

prone areas)

being optimal)

- Glazing to be Reduced- or low-reflectivity glass (0-10% reflectivity)

Section 4.2.3 Bird-friendly applications: micro scale of the Minimizing the

• installing internal screens as close to the glass as possible so as to

• attaching external screens to operable windows; (applicable in bushfire

• attaching exterior decorative grilles, provided the sections are less than-

wherever possible. Alternative options are set out in

reduced or low-reflectivity glass option.

28 cm wide (10 cm/handprint width

Some of these examples are:

Swift Parrot Collision Threat where unable to meet the

maximise the noise projected through the window



Revision 27/02/24

- slide: or

surface below are to be fitted with a device to limit cannot pass through. Except for Bedrooms, where the requirement is for heights above 2m. Refer to clauses 11.3.7 and 11.3.8 of NCC 2022 for further

All paths and patios to fall away from dwelling.

Note: Stair Construction

Vol II 2022 Part 11.2.2:

Going: Min 240mm - Max 355mm

For stairways serving non-habitable room used

Landings to comply with Clause 11.2.5 and be a

Slip resistance of treads, nosings and ramps to

10.3.1 of NCC 2022 Heights of rooms and other spaces must not be less

(a)in a habitable room excluding a kitchen - 2.4 m; and (b)in a kitchen - 2.1 m; and

compartment, airlock, pantry, storeroom, garage, car

directly for these items

(f)in a stairway, ramp, landing, or the like - 2.0 m landing or the like.

undertaking works.

130.18m² 25.00m²

> PINNACLE DRAFTING & DESIGN 7/3 Abernant Way, Cambridge 7170

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U1 - Floor Plan

1:100 Pg. No: A1.01

Scale:

250

CONCRETE PATIO

25.00 m

2,100 - 2,400 D01

LOUNGE

130.18 m²

FFL: 54,700

DINING

timber

KITCHEN

timber

ENS

tiles

BED 1

carpet

W06 1,500 - 2,100 AW

3,600

3,940

WIR

carpet

D02

(SA)

HALL

(SA)

GARAGE

congrete

-WW

BED 2

carpet

BATH

tiles

BÉD 3

carpet

1,200 - 1,800

3,000

5.050

M600M90

Address: 18 & 20 Kotona St, Rokeby 7019

DA 02 27.02.2024 DA 03 04.03.2024

000,

Site Plan, Floor Plans

Important Note

Important Note

- Glazing to be Reduced- or low-reflectivity glass (0-10% reflectivity) wherever possible. Alternative options are set out in Section 4.2.3 Bird-friendly applications: micro scale of the Minimizing the Swift Parrot Collision Threat where unable to meet the reduced or low-reflectivity glass option. Some of these examples are:

- installing internal screens as close to the glass as possible so as to maximise the noise projected through the window
- attaching external screens to operable windows; (applicable in bushfire prone areas)
- attaching exterior decorative grilles, provided the sections are less than 28 cm wide (10 cm/handprint width being optimal);



U1 - North Elevation

1:100



Clearances between cladding and ground shall comply with Clause 7.5.7 of the NCC 2022 and shall be a minimum clearance of:

100mm in low rainfall intensity areas or sandy, well-drained areas; or 50mm above impermeable areas that slope away from the building; or 150mm in any other case.

Wall cladding must extend a minimum of 50 mm below the bearer or lowest horizontal part of the suspended floor framing.

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Licence: CC6073Y

U1 - East Elevation

Scale:

1:100

Pg. No:

A1.02

U.N.O in builders specifications or located in saline environments or if using a glazed finish brick, brickwork is to be installed in stretcher bond pattern with raked joints.

Openable windows greater than 4m above ground level are to be fitted with a device to limit the opening or a suitable screen so a 125mm sphere cannot pass through, and withstand a force of 250N. Except for bedrooms, where the requirement is for heights above 2m.

Revision:

Approved by:

All stairs to be constructed in accordance with NCC 2022 Vol II Part 11.2.2 Riser: Min 115mm - Max 190mm Going: Min 240mm - Max 355mm

PINNACLE DRAFTING & DESIGN U1 - Elevations 7/3 Abernant Way, Cambridge 7170 PINNACLE 03 6248 4218 admin@pinnacledrafting.com.au

Slope (2R+G): Max 550 - Min 700

DA - 03

JM

Proposal: Unit Development Client: S & D Property Co Pty Ltd Address: 18 & 20 Kotona St, Rokeby 7019

25/01/2023 Drawn by: JSM/RZ Job No: 083-2023 Engineer: TBA

Building Surveyor: TBA

DA 02 27.02.2024 DA 03 04 03 2024

Site Plan, Floor Plans, Landscaping, Parking Amendments



1:100

Document Set ID: 5210465 Version: 1, Version Date: 04/03/2024

Important Note

- Glazing to be Reduced- or low-reflectivity glass (0-10% reflectivity) wherever possible. Alternative options are set out in Section 4.2.3 Bird-friendly applications: micro scale of the Minimizing the Swift Parrot Collision Threat where unable to meet the reduced or low-reflectivity glass option. Some of these examples are:

- installing internal screens as close to the glass as possible so as to maximise the noise projected through the window
- attaching external screens to operable windows; (applicable in bushfire prone areas)
- attaching exterior decorative grilles, provided the sections are less than 28 cm wide (10 cm/handprint width being optimal);



U1 - South Elevation

1:100



Clearances between cladding and ground shall comply with Clause 7.5.7 of the NCC 2022 and shall be a minimum clearance of:

100mm in low rainfall intensity areas or sandy, well-drained areas; or 50mm above impermeable areas that slope away from the building; or 150mm in any other case.

Wall cladding must extend a minimum of 50 mm below the bearer or lowest horizontal part of the suspended floor framing.

03 6248 4218

Licence: CC6073Y

admin@pinnacledrafting.com.au

www.pinnacledrafting.com.au

U1 - West Elevation

U.N.O in builders specifications or located in saline environments or if using a glazed finish brick, brickwork is to be installed in stretcher bond pattern with raked joints.

Openable windows greater than 4m above ground level are to be fitted with a device to limit the opening or a suitable screen so a 125mm sphere cannot pass through, and withstand a force of 250N. Except for bedrooms, where the requirement is for heights above 2m.

All stairs to be constructed in accordance with NCC 2022 Vol II Part 11.2.2 Riser: Min 115mm - Max 190mm Going: Min 240mm - Max 355mm

PINNACLE DRAFTING & DESIGN U1 - Elevations 7/3 Abernant Way, Cambridge 7170

Revision:

Approved by:

Slope (2R+G): Max 550 - Min 700

DA - 03

JM

Scale: Proposal: Unit Development 1:100 Client: S & D Property Co Pty Ltd Pg. No: Address: 18 & 20 Kotona St, Rokeby 7019

A1.03

Drawn by: JSM/RZ Job No: 083-2023 Engineer: TBA Building Surveyor: TBA

25/01/2023

DA 02 27.02.2024 DA 03 04 03 2024 Site Plan, Floor Plans, Landscaping, Parking Amendmen



1:100

Document Set ID: 5210465 Version: 1, Version Date: 04/03/2024

PINNACLE

Ventilation of roof spaces NCC 2022

Part 10.8.3

A roof must have a roof space that-(a)is located-

is located-

(i)immediately above the primary insulation layer; or

(ii)immediately above sarking with a vapour permeance of not less than 1.14 µg/N.s, which is immediately above the primary insulation layer; or

(iii)immediately above ceiling insulation; and (b)has a height of not less than 20 mm; and (c)is either-

(i)ventilated to outdoor air through evenly distributed openings in accordance with Table 10.8.3; or

(ii)located immediately underneath the roof tiles of an unsarked tiled roof.

Stormwater Notes

All gutters, downpipes and rain heads to be designed and installed in compliance with AS3500.3 & NCC 2022 Volume II Part 7.4.

Roofing Cladding

Roof cladding, flashings, cappings, roof sheeting and fixings are to be installed in accordance with NCC 2022 Volume II Part 7.2 for sheet roofing and Part 7.3 for tiled and shingle roofing.

Eaves & Soffit Linings

To comply with NCC 2022 Vol II Part 7.5.5 and where provided, external fibre-cement sheets and linings used as eaves and soffit linings must-


(a)comply with AS/NZS 2908.2 or ISO 8336; and (b)be fixed in accordance with Table 7.5.5 and Figure 7.5.5 using-

(i) 2.8×30 mm fibre-cement nails; or

(ii) No. 8 wafer head screws (for 4.5 mm and 6 mm sheets only); or $\,$

(iii) No. 8 self embedding head screws (for 6 mm sheets only)

Refer to table 7.5.5 for trimmer and fastener spacings.

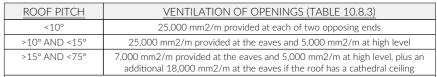

(1)Ventilation openings are specified as a minimum free open area per metre length of the longest horizontal dimension of the roof.

(2)For the purposes of this Table, high level openings are openings provided at the ridge or not more than 900 mm below the ridge or highest point of the roof space, measured vertically.

---REQUIRED NUMBER OF ROOF VENTS:

ROOF PITCH >15° and <75° HIP/GABLE ROOF


REQUIRED VENT AREA
Low Vents = 0.36m² (51.38m x 7,000mm2)
High Vents = 0.06m² (11.94m x 5,000mm2)

EAVE VENTS
BUILDERS EDGE EAVE VENT (EV4020) FITTED WITH
STAINLESS STEEL BUSHFIRE MESH
11x 400X200mm(0.035m²) VENTS EVENLY SPACED
OR

25mm CONTINUOUS VENT

RIDGE VENT SYSTEM
RIDGE CAP (Continuous 5mm gap in sarking)
1x GABLE VENTS 300x300mm (0.09m²)

NOTE: GABLE VENTS SHALL BE INSTALLED WITHIN 900mm OF RIDGE

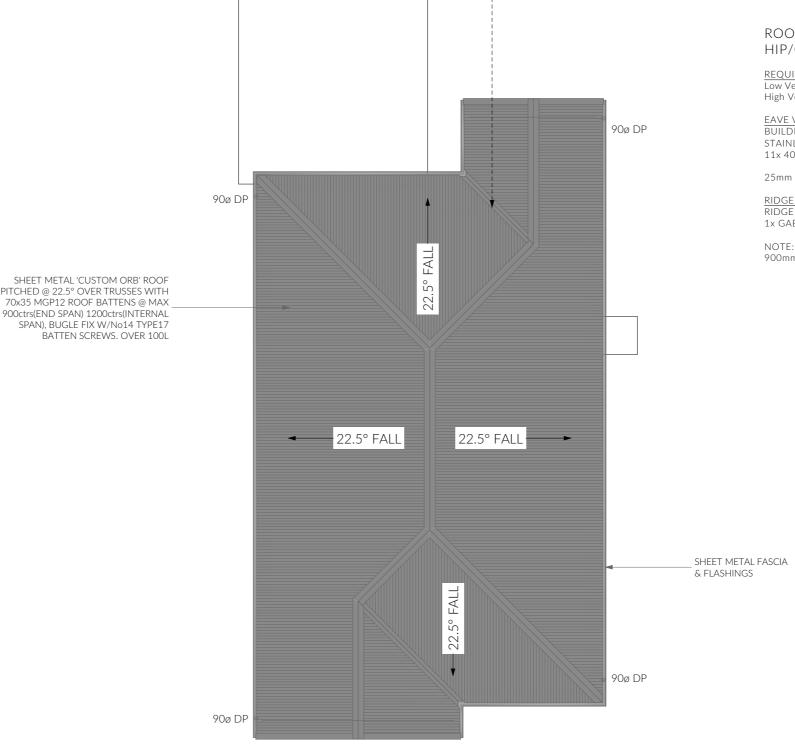

NOT FOR CONSTRUCTION



PINNACLE DRAFTING & DESIGN 7/3 Abernant Way, Cambridge 7170 03 6248 4218 admin@pinnacledrafting.com.au

03 6248 4218
admin@pinnacledrafting.com.au
www.pinnacledrafting.com.au
Licence: CC6073Y

Revision:
Approved by:

U1 - Roof Plan

DA - 03

JM

1:100 @ A Pg. No: A1.04

Scale:

Proposal: Unit Development

Client: S & D Property Co Pty Ltd

Address: 18 & 20 Kotona St, Rokeby 7019

Date: 25/01/2023
Drawn by: JSM/RZ
Job No: 083-2023
Engineer: TBA

Building Surveyor: TBA

DA 02 27.02.2024

DA 03 04.03.2024

Description
Site Plan, Floor Plans,
Landscaping, Parking Amendments
Shadow Disgrams



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ELECTRICAL LEGEND - UNIT 1

Symbol	Description	Allowance	Quantity
∇□	DATA - CAT 6 (RJ45) - 1 GANG		3
Ļ™	DATA - TV CONNECTION		3
В	FAN - 3 IN 1 (2 LAMP)	10W (LIGHT)	3
	FAN - 3 IN 1 (4 LAMP)	10W (LIGHT)	3
0	FAN - CEILING - EXHAUST		6
\vdash	GPO - (1) SINGLE		6
2	GPO - (2) DOUBLE		60
² /O	GPO - (2) DOUBLE (WITH COOKTOP ISOLATOR SWITCH)		3
10A 2	GPO - WEATHER PROOF DOUBLE		3
\bigotimes_{R}	LIGHT - CEILING - DOWNLIGHT RECESSED	10W	57
•	LIGHT - CEILING - PENDANT - LED STRIP 2000L	20W (LM)	3
	LIGHT - LED STRIP RECESSED CHANNEL	2W (LM)	6
w₁ ⊗	LIGHT - WALL MOUNTED - TYPE 1	10W	9
SA	SERVICE - SMOKE ALARM		6
Ь	SWITCH - LIGHT 1 GANG		24
2	SWITCH - LIGHT 2 GANG		15
4₫	SWITCH - LIGHT 4 GANG		3

Smoke Alarms Part 9.5 of NCC 2022

Smoke alarms must (a)be located in-

(i)a Class 1a building in accordance with 9.5.2 and 9.5.4; and (ii)a Class 1b building in accordance with 9.5.3 and 9.5.4;

(b)comply with AS 3786, except that in a Class 10a private garage where the use of the area is likely to result in smoke $% \left\{ 1\right\} =\left\{ 1$ alarms causing spurious signals, any other alarm deemed suitable in accordance with AS 1670.1 may be installed provided that smoke alarms complying with AS 3786 are installed elsewhere in the Class 1 building; and

(c)be powered from the consumer mains source where a consumer mains source is supplied to the building; and be interconnected where there is more than one alarm.

In a Class 1a building, smoke alarms must be located in-(a)any storey containing bedrooms, every corridor or hallway associated with a bedroom, or if there is no corridor or hallway, in an area between the bedrooms and the remainder of the building; and

(b) each other storey not containing bedrooms.

Smoke alarms required by 9.5.2 and 9.5.3 must be installed on or near the ceiling, in accordance with the following:

(a)Where a smoke alarm is located on the ceiling it must be-(i)a minimum of 300 mm away from the corner junction of the wall and ceiling; and

(ii)between 500 mm and 1500 mm away from the high point and apexes of the ceiling, if the room has a sloping ceiling. (b) Where (a) is not possible, the smoke alarm may be installed on the wall, and located a minimum of 300 mm and a maximum of 500 mm off the ceiling at the junction with the

Note: Exhaust Fans

Exhaust fans to comply with NCC 2022 Vol 2 Part 10.8.2 and have;

-An exhaust system installed in a kitchen, bathroom, sanitary compartment or laundry must have a minimum flow rate of (a)25 L/s for a bathroom or sanitary compartment; and (b)40 L/s for a kitchen or laundry.

-Exhaust from a kitchen, kitchen range hood, bathroom, sanitary compartment or laundry must discharge directly or via a shaft or duct to outdoor air.


Where a venting clothes dryer is installed, it must discharge directly or via a shaft or duct to outdoor air.

An exhaust system that is not run continuously and is serving a bathroom or sanitary compartment that is not ventilated in accordance with 10.6.2(a) must-


(a)be interlocked with the room's light switch; and (b)include a run-on timer so that the exhaust system continues to operate for 10 minutes after the light switch is turned off.

Preparation for future Solar Installation:

Should the solar design be required for future installation, 2/25mm solarflex (or similar) conduits marked "solar" are to be installed from the meter box to the roof space - See electrical

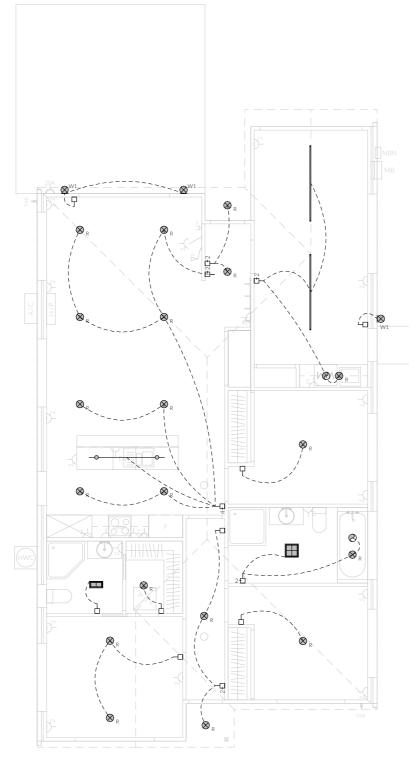

Electrical Plan - Light/Reflected Ceiling

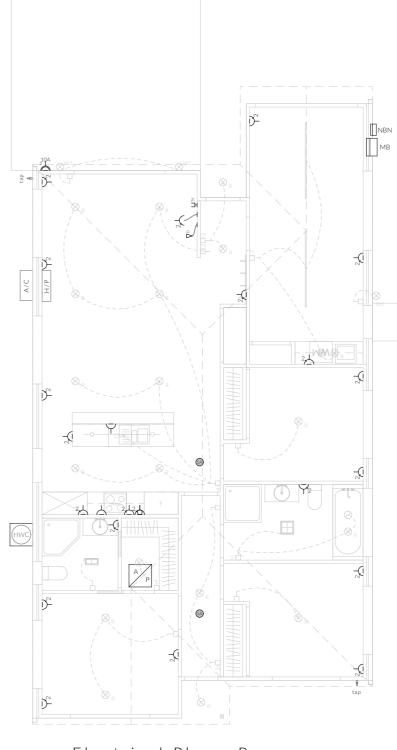

Electrical Plan - Power

Note: Lighting

Lighting layout may change, owner to confirm with builder prior to purchase/installation of exact quantity and location of electrical services provided that installation is compliant with AS3000 and artificial lighting allowances do not exceed:

5W/m² in class 1a dwellings

Approved by:

4W/m² to veranda, balcony or the like

3W/m² in a class 10a dwelling associated with the class 1a dwelling

U.N.O - All downlights are to be Insulation Contact (IC) rated.

JM

U.N.O ceilings are to be plasterboard.

--D----D - Dimmable Circuit

--т---т - Timer Circuit(as fan note)

PΒ - Plasterboard

CS - Cement Sheet Eaves

- Plywood Ceiling

-Timber Batten Ceiling

PINNACLE

PINNACLE DRAFTING & DESIGN 7/3 Abernant Way, Cambridge 7170 03 6248 4218 admin@pinnacledrafting.com.au www.pinnacledrafting.com.au

Licence: CC6073Y

U1 - Electrical Plan Revision: DA - 03

Scale: Pg. No: A1.05

Proposal: Unit Development Client: S & D Property Co Pty Ltd Address: 18 & 20 Kotona St, Rokeby 7019

25/01/2023 Drawn by: JSM/RZ Job No: 083-2023 Engineer: TBA

Building Surveyor: TBA

DA 02 27.02.2024 DA 03 04.03.2024

Site Plan, Floor Plans,





Articulation Joint

(SA) Smoke Alarm

Construction of sanitary

compartments 10.4.2 of NCC 2022

must -

unless there is a clear space of at least 1.2 m, measured in accordance with Figure 10.4.2 of NCC 2022 Vol II, between the closet pan within the sanitary compartment and the doorway.

opening or a suitable screen so a 125mm sphere information on suitable protective devices.

Vol II 2022 Part 11.2.2:

For stairways serving non-habitable room used infrequently, refer to table 11.2.2(b).

Landings to comply with Clause 11.2.5 and be a minimum of 750mm deep measured 500mm from the inside edge of the landing.

Slip resistance of treads, nosings and ramps to comply with Clause 11.2.4.

Heights of rooms & other spaces

10.3.1 of NCC 2022

(b)in a kitchen - 2.1 m; and

directly for these items

measured vertically above the nosing line of stairway treads or the floor surface of a ramp, landing or the like.

If required onsite, the builder may work within the 2022 Vol II. Builder to contact Pinnacle before

130.18m²

Revision 27/02/24

Important Note

- Glazing to be Reduced- or low-reflectivity glass (0-10% reflectivity) wherever possible. Alternative options are set out in Section 4.2.3 Bird-friendly applications: micro scale of the Minimizing the Swift Parrot Collision

Threat where unable to meet the reduced or low-reflectivity glass option. Some of these examples are:

- installing internal screens as close to the glass as possible so as to maximise the noise projected through the window
- attaching external screens to operable
- windows; (applicable in bushfire prone areas) • attaching exterior decorative grilles, provided

the sections are less than 28 cm wide (10 cm/handprint width being optimal):



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U2 - Floor Plan

Scale: 1:100 Pg. No:

009

80%

1,910

806

41,000 H

% A W 9 9

Proposal: Unit Development Client: S & D Property Co Pty Ltd

250

Drawn by: JSM/RZ Job No: 083-2023 Engineer: TBA

Building Surveyor: TBA

5,050

M600M90

9,550

90 W 1,210 W

250

CONCRETE PATIO 25.00 m²

D01

LOUNGE

timber 130.18 m²

CH:2400 FFL: 53,700

DINING

timber

DV₩∏∏

WIR

arpet

KITCHEN

timber

ENS

tiles

BED 1

1,500 - 2,100

3,940

SA

HALL

600

90 90

250

GARAGE

congrete

LAUNDRY

BED 2

carpet

BED 3

carpet

1,200 - 1,800

3,000

25/01/2023

250

BATH


tiles

- MM

Site Plan, Floor Plans andscaping, Parking Ame





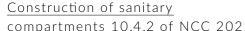

The door to a fully enclosed sanitary compartment

- open outwards; or
- slide: or
- be readily removable from the outside of the compartment.

Note: Safe Movement & Egress

Openable windows greater than 4m above the surface below are to be fitted with a device to limit cannot pass through. Except for Bedrooms, where the requirement is for heights above 2m. Refer to clauses 11.3.7 and 11.3.8 of NCC 2022 for further

Note: Paved Areas

All paths and patios to fall away from dwelling.

Note: Stair Construction

All stairs to be constructed in accordance with NCC

Riser: Min 115mm - Max 190mm Going: Min 240mm - Max 355mm

Slope (2R+G): Max 550 - Min 700

Heights of rooms and other spaces must not be less

(a)in a habitable room excluding a kitchen - 2.4 m; and

(c)in a corridor, passageway or the like - 2.1 m; and (d)in a bathroom, shower room, laundry, sanitary compartment, airlock, pantry, storeroom, garage, car

parking area or the like - 2.1 m; and (e)in a room or space with a sloping ceiling or projections below the ceiling line within- See NCC

(f)in a stairway, ramp, landing, or the like - 2.0 m

tolerances of the above as specified within the NCC undertaking works.

Floor Areas

Total Floor Area

25.00m²

PINNACLE

PINNACLE DRAFTING & DESIGN 7/3 Abernant Way, Cambridge 7170 03 6248 4218 admin@pinnacledrafting.com.au

Revision: Approved by:

JM

DA - 03

A2.01

Address: 18 & 20 Kotona St, Rokeby 7019

ssue Date DA 02 27.02.2024 DA 03 04 03 2024

Important Note

- Glazing to be Reduced- or low-reflectivity glass (0-10% reflectivity) wherever possible. Alternative options are set out in Section 4.2.3 Bird-friendly applications: micro scale of the Minimizing the Swift Parrot Collision Threat where unable to meet the reduced or low-reflectivity glass option. Some of these examples are:

- installing internal screens as close to the glass as possible so as to maximise the noise projected through the window
- attaching external screens to operable windows; (applicable in bushfire prone areas)
- attaching exterior decorative grilles, provided the sections are less than 28 cm wide (10 cm/handprint width being optimal);

JAMES HARDIE SCYON STRIA CLADDING, CB 'MATT DUNE' PAINT FINISH, INSTALLED WITH A VENTILATED CAVITY

CONCRETE PATIO

FALL GROUND AWAY FROM HOUSE A MINIMUM OF 50mm OVER THE FIRST 1000mm IN ACCORDANCE WITH AS2870, NCC 2022 PART 3.3.3 & Fig.

U2 - North Elevation

1:100



Clearances between cladding and ground shall comply with Clause 7.5.7 of the NCC 2022 and shall be a minimum clearance of:

100mm in low rainfall intensity areas or sandy, well-drained areas; or 50mm above impermeable areas that slope away from the building; or 150mm in any other case.

Wall cladding must extend a minimum of 50 mm below the bearer or lowest horizontal part of the suspended floor framing.

U2 - East Elevation

U.N.O in builders specifications or located in saline environments or if using a glazed finish brick, brickwork is to be installed in stretcher bond pattern with raked joints.

Openable windows greater than 4m above ground level are to be fitted with a device to limit the opening or a suitable screen so a 125mm sphere cannot pass through, and withstand a force of 250N. Except for bedrooms, where the requirement is for heights above 2m.

All stairs to be constructed in accordance with NCC 2022 Vol II Part 11.2.2 Riser: Min 115mm - Max 190mm

'CUSTOM ORB' SHEET METAL ROOF

JAMES HARDIE SCYON AXON CLADDING, CB 'MATT DUNE' PAINT

CONTROLLED FILL IN COMPLIANCE WITH NCC VOL II PART 3.2.1, AS2870 & AS3798

FINISH, INSTALLED WITH A VENTILATED CAVITY

CL

0 Ground

PITCHED @ 22.5°

- CB MATT DUNE

Going: Min 240mm - Max 355mm PINNACLE DRAFTING & DESIGN

Revision:

Approved by:

Slope (2R+G): Max 550 - Min 700

DA - 03

JM

FOR

PINNACLE

7/3 Abernant Way, Cambridge 7170 03 6248 4218 admin@pinnacledrafting.com.au www.pinnacledrafting.com.au

Licence: CC6073Y

U2 - Elevations

Scale: 1:100 @ A3 Pg. No: A2.02

Proposal: Unit Development Client: S & D Property Co Pty Ltd Address: 18 & 20 Kotona St, Rokeby 7019

25/01/2023 Drawn by: JSM/RZ Job No: 083-2023 Engineer: TBA

Building Surveyor: TBA

DA 02 27.02.2024 DA 03 04 03 2024

Site Plan, Floor Plans, Landscaping, Parking Amendmen rders, works or requesting/producing shop drawings. ANY AND AI ISCREPANCIES DISCOVERED BY OUTSIDE PARTIES ARE TO BE ROUGHT TO THE ATTENTION OF THE PINNACLE DRAFTING &



1:100

Document Set ID: 5210465 Version: 1, Version Date: 04/03/2024

Important Note

- Glazing to be Reduced- or low-reflectivity glass (0-10% reflectivity) wherever possible. Alternative options are set out in Section 4.2.3 Bird-friendly applications: micro scale of the Minimizing the Swift Parrot Collision Threat where unable to meet the reduced or low-reflectivity glass option. Some of these examples are:

- installing internal screens as close to the glass as possible so as to maximise the noise projected through the window
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being optimal); JAMES HARDIE SCYON AXON 'CUSTOM ORB' SHEET METAL ROOF CLADDING, CB 'MATT DUNE' PAINT PITCHED @ 22.5° FINISH, INSTALLED WITH A - CB MATT DUNE VENTILATED CAVITY 190mm RETAINING BLOCK WALL JAMES HARDIE SCYON STRIA CLADDING, CB 'MATT DUNE' PAINT FINISH, INSTALLED WITH A VENTILATED CAVITY MGL FALL GROUND AWAY FROM HOUSE A MINIMUM OF 50mm OVER THE FIRST 1000mm IN ACCORDANCE WITH-

U2 -South Elevation

1:100



joints.

Clearances between cladding and ground shall comply with Clause 7.5.7 of the NCC 2022 and shall be a minimum clearance of:

100mm in low rainfall intensity areas or sandy, well-drained areas; or 50mm above impermeable areas that slope away from the building; or 150mm in any other case.

Wall cladding must extend a minimum of 50 mm below the bearer or lowest horizontal part of the suspended floor framing.

U2 - West Elevation

U.N.O in builders specifications or located in saline environments or if using a glazed finish brick, brickwork is to be installed in stretcher bond pattern with raked

CL

+53,700 0 Ground

AS2870, NCC 2022 PART 3.3.3 & Fig.

Openable windows greater than 4m above ground level are to be fitted with a device to limit the opening or a suitable screen so a 125mm sphere cannot pass through, and withstand a force of 250N. Except for bedrooms, where the requirement is for heights above 2m.

All stairs to be constructed in accordance with NCC 2022 Vol II Part 11.2.2 Riser: Min 115mm - Max 190mm

Going: Min 240mm - Max 355mm PINNACLE DRAFTING & DESIGN 7/3 Abernant Way, Cambridge 7170 Slope (2R+G): Max 550 - Min 700

JM

FOR

PINNACLE

03 6248 4218 admin@pinnacledrafting.com.au www.pinnacledrafting.com.au

Licence: CC6073Y

U2 - Elevations

Revision:

Approved by:

Scale: 1:100 Pg. No: DA - 03 A2.03

Proposal: Unit Development

Client: S & D Property Co Pty Ltd Address: 18 & 20 Kotona St, Rokeby 7019

25/01/2023 Drawn by: JSM/RZ Job No: 083-2023 Engineer: TBA

Building Surveyor: TBA

DA 02 27.02.2024 DA 03 04 03 2024

Site Plan, Floor Plans, Landscaping, Parking Amendmen



1:100

Document Set ID: 5210465 Version: 1, Version Date: 04/03/2024

Ventilation of roof spaces NCC 2022

Part 10.8.3

A roof must have a roof space that-(a)is located-

(i)immediately above the primary insulation layer;

or
(ii)immediately above sarking with a vapour permeance of not less than 1.14 µg/N.s, which is immediately above the primary insulation layer;

or
(iii)immediately above ceiling insulation; and
(b)has a height of not less than 20 mm; and
(c)is either-

(i)ventilated to outdoor air through evenly distributed openings in accordance with Table 10.8.3; or

(ii)located immediately underneath the roof tiles of an unsarked tiled roof.

Stormwater Notes

All gutters, downpipes and rain heads to be designed and installed in compliance with AS3500.3 & NCC 2022 Volume II Part 7.4.

Roofing Cladding

Roof cladding, flashings, cappings, roof sheeting and fixings are to be installed in accordance with NCC 2022 Volume II Part 7.2 for sheet roofing and Part 7.3 for tiled and shingle roofing.

Eaves & Soffit Linings

To comply with NCC 2022 Vol II Part 7.5.5 and where provided, external fibre-cement sheets and linings used as eaves and soffit linings must-


(a)comply with AS/NZS 2908.2 or ISO 8336; and (b)be fixed in accordance with Table 7.5.5 and Figure 7.5.5 using-

(i) 2.8×30 mm fibre-cement nails; or

(ii) No. 8 wafer head screws (for 4.5 mm and 6 mm sheets only); or

(iii) No. 8 self embedding head screws (for 6 mm sheets only)

Refer to table 7.5.5 for trimmer and fastener spacings.

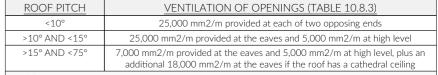

(1)Ventilation openings are specified as a minimum free open area per metre length of the longest horizontal dimension of the roof.

(2)For the purposes of this Table, high level openings are openings provided at the ridge or not more than 900 mm below the ridge or highest point of the roof space, measured vertically.

-REQUIRED NUMBER OF ROOF VENTS:


ROOF PITCH >15° and <75° HIP/GABLE ROOF

REQUIRED VENT AREA
Low Vents = 0.36m² (51.38m x 7,000mm2)
High Vents = 0.06m² (11.94m x 5,000mm2)

EAVE VENTS
BUILDERS EDGE EAVE VENT (EV4020) FITTED WITH
STAINLESS STEEL BUSHFIRE MESH
11x 400X200mm(0.035m²) VENTS EVENLY SPACED
OR
25mm CONTINUOUS VENT

RIDGE VENT SYSTEM
RIDGE CAP (Continuous 5mm gap in sarking)
1x GABLE VENTS 300x300mm (0.09m²)

NOTE: GABLE VENTS SHALL BE INSTALLED WITHIN 900mm OF RIDGE

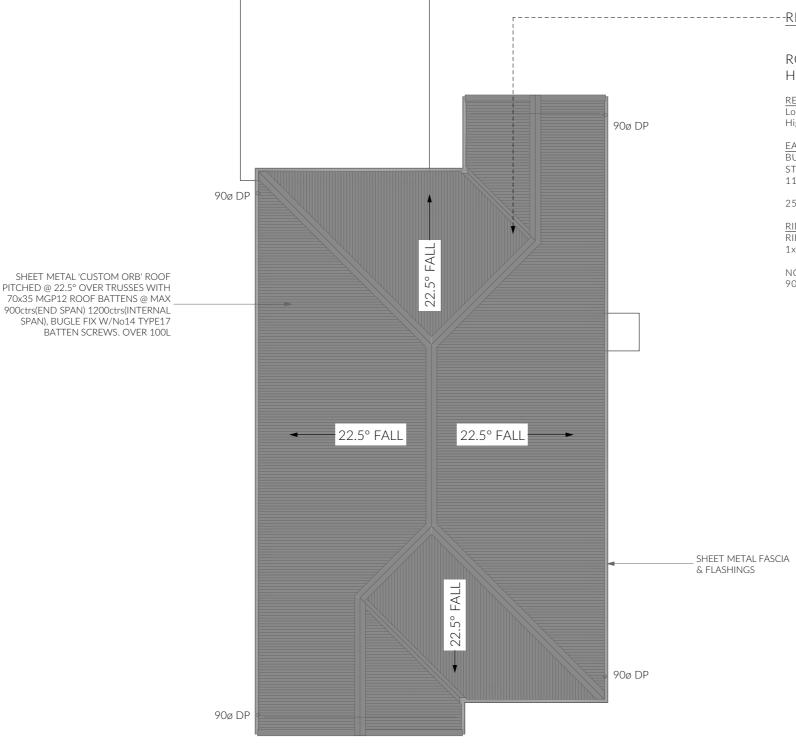

NOT FOR CONSTRUCTION



PINNACLE DRAFTING & DESIGN 7/3 Abernant Way, Cambridge 7170 03 6248 4218 admin@pinnacledrafting.com.au

www.pinnacledrafting.com.au

Licence: CC6073Y

U2 - Roof Plan

Approved by:

DA - 03

JM

Scale: 1:100 @ A Pg. No: A2.04 Proposal: Unit Development

Client: S & D Property Co Pty Ltd

Address: 18 & 20 Kotona St, Rokeby 7019

Date: 25/01/2023
Drawn by: JSM/RZ
Job No: 083-2023
Engineer: TBA

Building Surveyor: TBA

DA 02 27.02.2024

Site Plan, Floor Plans, Landscaping, Parking Amendments Shadow Diagrams



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ELECTRICAL LEGEND - UNIT 2

	ELECTRICAL LEGEND OTT	_	
Symbol	Description	Allowance	Quantity
V°	DATA - CAT 6 (RJ45) - 1 GANG		3
Ψīv	DATA - TV CONNECTION		3
8	FAN - 3 IN 1 (2 LAMP)	10W (LIGHT)	3
	FAN - 3 IN 1 (4 LAMP)	10W (LIGHT)	3
0	FAN - CEILING - EXHAUST		6
\perp	GPO - (1) SINGLE		6
2,1	GPO - (2) DOUBLE		60
2,6	GPO - (2) DOUBLE (WITH COOKTOP ISOLATOR SWITCH)		3
20A 210A 210A	GPO - WEATHER PROOF DOUBLE		3
$\otimes_{_{R}}$	LIGHT - CEILING - DOWNLIGHT RECESSED	10W	57
•	LIGHT - CEILING - PENDANT - LED STRIP 2000L	20W (LM)	3
	LIGHT - LED STRIP RECESSED CHANNEL	2W (LM)	6
w₁ ⊗	LIGHT - WALL MOUNTED - TYPE 1	10W	9
	SERVICE - SMOKE ALARM		6
Ь	SWITCH - LIGHT 1 GANG		24
2 🗖	SWITCH - LIGHT 2 GANG		15
4廿	SWITCH - LIGHT 4 GANG		3

Smoke Alarms Part 9.5 of NCC 2022

Smoke alarms must (a)be located in-

(i)a Class 1a building in accordance with 9.5.2 and 9.5.4; and (ii)a Class 1b building in accordance with 9.5.3 and 9.5.4; and

(b)comply with AS 3786, except that in a Class 10a private garage where the use of the area is likely to result in smoke alarms causing spurious signals, any other alarm deemed suitable in accordance with AS 1670.1 may be installed provided that smoke alarms complying with AS 3786 are installed elsewhere in the Class 1 building; and

(c)be powered from the consumer mains source where a consumer mains source is supplied to the building; and be interconnected where there is more than one alarm.

In a Class 1a building, smoke alarms must be located in-(a)any storey containing bedrooms, every corridor or hallway associated with a bedroom, or if there is no corridor or hallway, in an area between the bedrooms and the remainder of the building; and

(b) each other storey not containing bedrooms.

Smoke alarms required by 9.5.2 and 9.5.3 must be installed on or near the ceiling, in accordance with the following: $\frac{1}{2} \left(\frac{1}{2} \right) = \frac{1}{2} \left(\frac{1}{2} \right) \left(\frac{$

(a)Where a smoke alarm is located on the ceiling it must be(i)a minimum of 300 mm away from the corner junction of
the wall and ceiling; and

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 -Exhaust from a kitchen, kitchen range hood, bathroom, sanitary compartment or laundry must discharge directly or via a shaft or duct to outdoor air.


-Where a venting clothes dryer is installed, it must discharge directly or via a shaft or duct to outdoor air.

-An exhaust system that is not run continuously and is serving a bathroom or sanitary compartment that is not ventilated in accordance with 10.6.2(a) must-

(a)be interlocked with the room's light switch; and (b)include a run-on timer so that the exhaust system continues to operate for 10 minutes after the light switch is turned off.

Preparation for future Solar Installation:

Should the solar design be required for future installation, $2/25 \, \text{mm}$ solarflex (or similar) conduits marked "solar" are to be installed from the meter box to the roof space - See electrical plan.

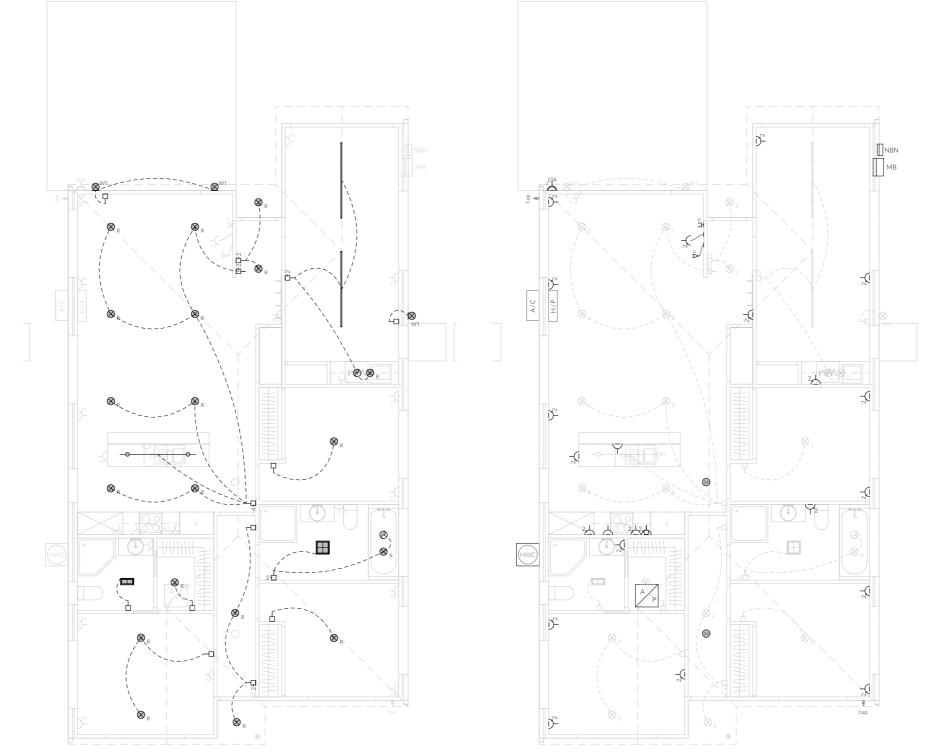

Electrical Plan - Light/Reflected Ceiling

Scale:

Pg. No:

A2.05

Electrical Plan - Power

Note: Lighting

Lighting layout may change, owner to confirm with builder prior to purchase/installation of exact quantity and location of electrical services provided that installation is compliant with AS3000 and artificial lighting allowances do not exceed:

5W/m² in class 1a dwellings

4W/m² to veranda, balcony or the like

3W/m² in a class 10a dwelling associated with the class 1a dwelling

U.N.O - All downlights are to be Insulation Contact (IC) rated.

Notes

U.N.O ceilings are to be plasterboard.

---- - Dimmable Circuit

--т---т - Timer Circuit(as fan note)

PB - Plasterboard

CS - Cement Sheet Eaves

PW - Plywood Ceiling

NOTEOR CONSTBRITION

PINNACLE

PINNACLE DRAFTING & DESIGN 7/3 Abernant Way, Cambridge 7170 03 6248 4218 admin@pinnacledrafting.com.au www.pinnacledrafting.com.au

Licence: CC6073Y

U2 - Electrical Plan

Revision: DA - 03
Approved by: JM

Proposal: Unit Development
Client: S & D Property Co Pty Ltd
Address: 18 & 20 Kotona St, Rokeby 7019

Date: 25/01/2023 Drawn by: JSM/RZ Job No: 083-2023 Engineer: TBA

Building Surveyor: TBA

DA 02 27.02.2024

DA 03 04.03.2024

Description
Site Plan, Floor Plans,
Landscaping, Parking Amendme

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Articulation Joint

(SA) Smoke Alarm

must -

unless there is a clear space of at least 1.2 m, sanitary compartment and the doorway.

Note: Safe Movement & Egress

Openable windows greater than 4m above the opening or a suitable screen so a 125mm sphere cannot pass through. Except for Bedrooms, where the requirement is for heights above 2m. Refer to information on suitable protective devices.

Note: Paved Areas

All paths and patios to fall away from dwelling.

Note: Stair Construction

All stairs to be constructed in accordance with NCC

Going: Min 240mm - Max 355mm

For stairways serving non-habitable room used

infrequently, refer to table 11.2.2(b).

the inside edge of the landing.

comply with Clause 11.2.4.

Heights of rooms & other spaces

10.3.1 of NCC 2022

(b)in a kitchen - 2.1 m; and

directly for these items

If required onsite, the builder may work within the

Floor Areas

Total Floor Area

130.18m² 25.44m²

PINNACLE 03 6248 4218 U3 - Floor Plan

Revision:

Approved by:

1:100 Pg. No: A2.01

Proposal: Unit Development Client: S & D Property Co Pty Ltd

3,000

5,050

Date: 25/01/2023 Drawn by: JSM/RZ Job No: 083-2023 Engineer: TBA

Building Surveyor: TBA

3.600

3,940

5.000

CONCRETE PATIO 25.44 m²

LOUNGE

timber

130.18 m²

CH:2400 FFL: 53,300

DINING

timber

KITCHEN

timber

tiles

BED 1

WIR

carpe

@

HALL

timber

<u>@</u>

90

9,990

9016001

250

* **

4,100

yy 1,210 yy90

90 90

250

CONC. L'DING 0.80 m²

W 02

8

GARAGE

congrete

₩w⊮⊦

BED 2

carpet

BED, 3

carpet

250

BATH

tiles

ssue Date DA 02 27.02.2024 Site Plan, Floor Plans andscaping, Parking Ame DA 03 04 03 2024

1,910

06



Construction of sanitary

compartments 10.4.2 of NCC 2022

The door to a fully enclosed sanitary compartment

- open outwards; or
- slide: or
- be readily removable from the outside of the compartment.

measured in accordance with Figure 10.4.2 of NCC 2022 Vol II, between the closet pan within the

surface below are to be fitted with a device to limit clauses 11.3.7 and 11.3.8 of NCC 2022 for further

Vol II 2022 Part 11.2.2:

Riser: Min 115mm - Max 190mm

Slope (2R+G): Max 550 - Min 700

Landings to comply with Clause 11.2.5 and be a minimum of 750mm deep measured 500mm from

Slip resistance of treads, nosings and ramps to

Heights of rooms and other spaces must not be less

(a)in a habitable room excluding a kitchen - 2.4 m; and

(c)in a corridor, passageway or the like - 2.1 m; and (d)in a bathroom, shower room, laundry, sanitary compartment, airlock, pantry, storeroom, garage, car

parking area or the like - 2.1 m; and (e)in a room or space with a sloping ceiling or projections below the ceiling line within- See NCC

(f)in a stairway, ramp, landing, or the like - 2.0 m measured vertically above the nosing line of stairway treads or the floor surface of a ramp, landing or the like.

tolerances of the above as specified within the NCC 2022 Vol II. Builder to contact Pinnacle before undertaking works.

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www.pinnacledrafting.com.au Licence: CC6073Y

DA - 03 JM

Scale:

Address: 18 & 20 Kotona St, Rokeby 7019

Important Note

unable to meet the

the window

being optimal);

width

Glazing to be Reduced- or low-reflectivity glass (0-10%

reflectivity) wherever possible. Alternative options are

Section 4.2.3 Bird-friendly applications: micro scale of the Minimizing the Swift Parrot Collision Threat where

• installing internal screens as close to the glass as

• attaching external screens to operable windows;

• attaching exterior decorative grilles, provided the

sections are less than 28 cm wide (10 cm/handprint

Revision 27/02/24

possible so as to maximise the noise projected through

reduced or low-reflectivity glass option.

(applicable in bushfire prone areas)

Some of these examples are:

Important Note

- Glazing to be Reduced- or low-reflectivity glass (0-10% reflectivity) wherever possible. Alternative options are set out in Section 4.2.3 Bird-friendly applications: micro scale of the Minimizing the Swift Parrot Collision Threat where unable to meet the reduced or low-reflectivity glass option. Some of these examples are:

- installing internal screens as close to the glass as possible so as to maximise the noise projected through the window
- attaching external screens to operable windows; (applicable in bushfire prone areas)
- attaching exterior decorative grilles, provided the sections are less than 28 cm wide (10 cm/handprint width being optimal);

'CUSTOM ORB' SHEET METAL ROOF -PITCHED @ 22.5° - CB MATT DUNE JAMES HARDIE SCYON STRIA CLADDING, CB 'MATT DUNE' PAINT FINISH, INSTALLED WITH A VENTILATED CAVITY CLJAMES HARDIE SCYON AXON MIN. 1.7m PERMANENTLY FIXED PRIVACY CLADDING, CB 'MATT DUNE' PAINT SCREEN ABOVE FFL, WITH A UNIFORM FINISH, INSTALLED WITH A TRANSPARENCY OF NOT MORE THAN 25% VENTILATED CAVITY CONCRETE PATIO -NGL

U3 -North Elevation

1:100



joints.

Clearances between cladding and ground shall comply with Clause 7.5.7 of the NCC 2022 and shall be a minimum clearance of:

100mm in low rainfall intensity areas or sandy, well-drained areas; or 50mm above impermeable areas that slope away from the building; or 150mm in any other case.

Wall cladding must extend a minimum of 50 mm below the bearer or lowest horizontal part of the suspended floor framing.

U3 - East Elevation

U.N.O in builders specifications or located in saline environments or if using a glazed finish brick, brickwork is to be installed in stretcher bond pattern with raked

Openable windows greater than 4m above ground level are to be fitted with a device to limit the opening or a suitable screen so a 125mm sphere cannot pass through,

All stairs to be constructed in accordance with NCC 2022 Vol II Part 11.2.2 Riser: Min 115mm - Max 190mm

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Licence: CC6073Y

Slope (2R+G): Max 550 - Min 700

Proposal: Unit Development Client: S & D Property Co Pty Ltd 25/01/2023

DA 02 27.02.2024

Site Plan, Floor Plans,



1:100

Document Set ID: 5210465 Version: 1, Version Date: 04/03/2024

and withstand a force of 250N. Except for bedrooms, where the requirement is for heights above 2m.

Going: Min 240mm - Max 355mm

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U3 - Elevations

Revision: DA - 03 Approved by: JM

1:100 @ A3 Pg. No: A2.02

Scale:

Address: 18 & 20 Kotona St, Rokeby 7019

Drawn by: JSM/RZ Job No: 083-2023 Engineer: TBA

Building Surveyor: TBA

DA 03 04.03.2024


Landscaping, Parking Amendmen

FOR

Important Note

- Glazing to be Reduced- or low-reflectivity glass (0-10% reflectivity) wherever possible. Alternative options are set out in Section 4.2.3 Bird-friendly applications: micro scale of the Minimizing the Swift Parrot Collision Threat where unable to meet the reduced or low-reflectivity glass option. Some of these examples are:

- installing internal screens as close to the glass as possible so as to maximise the noise projected through the window
- attaching external screens to operable windows; (applicable in bushfire prone areas)
- attaching exterior decorative grilles, provided the sections are less than 28 cm wide (10 cm/handprint width being optimal);

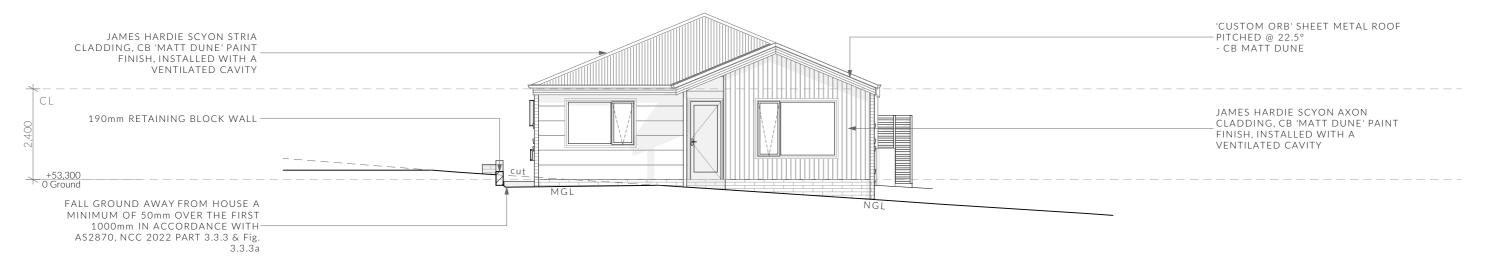

U3 -South Elevation

1:100



Clearances between cladding and ground shall comply with Clause 7.5.7 of the NCC 2022 and shall be a minimum clearance of:

100mm in low rainfall intensity areas or sandy, well-drained areas; or 50mm above impermeable areas that slope away from the building; or 150mm in any other case.

Wall cladding must extend a minimum of 50 mm below the bearer or lowest horizontal part of the suspended floor framing.

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Licence: CC6073Y

U3 - West Elevation

U.N.O in builders specifications or located in saline environments or if using a glazed finish brick, brickwork is to be installed in stretcher bond pattern with raked joints.

Openable windows greater than 4m above ground level are to be fitted with a device to limit the opening or a suitable screen so a 125mm sphere cannot pass through, and withstand a force of 250N. Except for bedrooms, where the requirement is for heights above 2m.

Revision:

Approved by:

All stairs to be constructed in accordance with NCC 2022 Vol II Part 11.2.2 Riser: Min 115mm - Max 190mm Going: Min 240mm - Max 355mm

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Slope (2R+G): Max 550 - Min 700

DA - 03

JM

U3 - Elevations Scale: Proposal: Unit Development 1:100

Pg. No:

A2.03

Client: S & D Property Co Pty Ltd Address: 18 & 20 Kotona St, Rokeby 7019

25/01/2023 Drawn by: JSM/RZ Job No: 083-2023 Engineer: TBA

Building Surveyor: TBA

DA 02 27.02.2024 DA 03 04.03.2024

Site Plan, Floor Plans, Landscaping, Parking Amendmen

FOR



1:100

Document Set ID: 5210465 Version: 1, Version Date: 04/03/2024

Ventilation of roof spaces NCC 2022

Part 10.8.3

A roof must have a roof space that-(a)is located-

(i)immediately above the primary insulation layer;

(ii)immediately above sarking with a vapour permeance of not less than 1.14 μ g/N.s, which is immediately above the primary insulation layer; or

(iii)immediately above ceiling insulation; and (b)has a height of not less than 20 mm; and (c)is either-

(i)ventilated to outdoor air through evenly distributed openings in accordance with Table 10.8.3; or

(ii)located immediately underneath the roof tiles of an unsarked tiled roof.

Stormwater Notes

All gutters, downpipes and rain heads to be designed and installed in compliance with AS3500.3 & NCC 2022 Volume II Part 7.4.

Roofing Cladding

Roof cladding, flashings, cappings, roof sheeting and fixings are to be installed in accordance with NCC 2022 Volume II Part 7.2 for sheet roofing and Part 7.3 for tiled and shingle roofing.

Eaves & Soffit Linings

To comply with NCC 2022 Vol II Part 7.5.5 and where provided, external fibre-cement sheets and linings used as eaves and soffit linings must-

(a)comply with AS/NZS 2908.2 or ISO 8336; and (b)be fixed in accordance with Table 7.5.5 and Figure 7.5.5 using-


(i) 2.8×30 mm fibre-cement nails; or (ii) No. 8 wafer head screws (for 4.5 mm and 6 mm

sheets only); or

(iii) No. 8 self embedding head screws (for 6 mg

(iii) No. 8 self embedding head screws (for 6 mm sheets only)

Refer to table 7.5.5 for trimmer and fastener spacings.

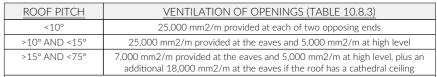

(1)Ventilation openings are specified as a minimum free open area per metre length of the longest horizontal dimension of the roof.

(2)For the purposes of this Table, high level openings are openings provided at the ridge or not more than 900 mm below the ridge or highest point of the roof space, measured vertically.

---REQUIRED NUMBER OF ROOF VENTS:

ROOF PITCH >15° and <75° HIP/GABLE ROOF

REQUIRED VENT AREA

Low Vents = 0.36m² (51.38m x 7,000mm2) High Vents = 0.06m² (11.94m x 5,000mm2)

EAVE VENTS


BUILDERS EDGE EAVE VENT (EV4020) FITTED WITH STAINLESS STEEL BUSHFIRE MESH 11x 400X200mm(0.035m²) VENTS EVENLY SPACED

25mm CONTINUOUS VENT

RIDGE VENT SYSTEM

RIDGE CAP (Continuous 5mm gap in sarking) 1x GABLE VENTS 300x300mm (0.09m²)

NOTE: GABLE VENTS SHALL BE INSTALLED WITHIN 900mm OF RIDGE

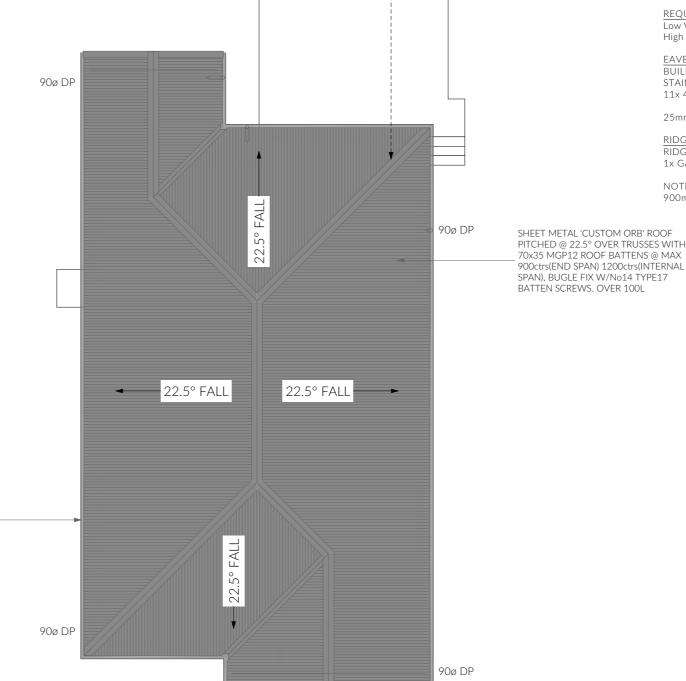

NOI FOR CONSTRUCTION



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Licence: CC6073Y

U3 - Roof Plan
Revision:

Approved by:

DA - 03

JM

SHEET METAL FASCIA & FLASHINGS

> Scale: 1:100 @ A Pg. No: A2.04

Proposal: Unit Development

Client: S & D Property Co Pty Ltd

Address: 18 & 20 Kotona St, Rokeby 7019

Date: 25/01/2023

Drawn by: JSM/RZ

Job No: 083-2023

Engineer: TBA

Building Surveyor: TBA

DA 02 27.02.2024

Site Plan, Floor Plans, Landscaping, Parking Amendments Shadow Diagrams



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FLECTRICAL LEGEND - UNIT 3

Symbol	Description	Allowance	Quantity
∇°	DATA - CAT 6 (RJ45) - 1 GANG		3
ЦIV	DATA - TV CONNECTION		3
	FAN - 3 IN 1 (2 LAMP)	10W (LIGHT)	3
	FAN - 3 IN 1 (4 LAMP)	10W (LIGHT)	3
0	FAN - CEILING - EXHAUST		6
\forall	GPO - (1) SINGLE		6
2	GPO - (2) DOUBLE		60
26	GPO - (2) DOUBLE (WITH COOKTOP ISOLATOR SWITCH)		3
10A	GPO - WEATHER PROOF DOUBLE		3
$\otimes_{_{R}}$	LIGHT - CEILING - DOWNLIGHT RECESSED	10W	57
• •	- LIGHT - CEILING - PENDANT - LED STRIP 2000L	20W (LM)	3
	LIGHT - LED STRIP RECESSED CHANNEL	2W (LM)	6
w₁	LIGHT - WALL MOUNTED - TYPE 1	10W	9
	SERVICE - SMOKE ALARM		6
Ь	SWITCH - LIGHT 1 GANG		24
2 🗖	SWITCH - LIGHT 2 GANG		15
4廿	SWITCH - LIGHT 4 GANG		3

Smoke Alarms Part 9.5 of NCC 2022

Smoke alarms must (a)be located in-

(i)a Class 1a building in accordance with 9.5.2 and 9.5.4; and (ii)a Class 1b building in accordance with 9.5.3 and 9.5.4;

(b)comply with AS 3786, except that in a Class 10a private garage where the use of the area is likely to result in smoke $% \left\{ 1\right\} =\left\{ 1$ alarms causing spurious signals, any other alarm deemed suitable in accordance with AS 1670.1 may be installed provided that smoke alarms complying with AS 3786 are installed elsewhere in the Class 1 building; and

(c)be powered from the consumer mains source where a consumer mains source is supplied to the building; and be interconnected where there is more than one alarm.

In a Class 1a building, smoke alarms must be located in-(a)any storey containing bedrooms, every corridor or hallway associated with a bedroom, or if there is no corridor or hallway, in an area between the bedrooms and the remainder of the building; and

(b) each other storey not containing bedrooms.

Smoke alarms required by 9.5.2 and 9.5.3 must be installed on or near the ceiling, in accordance with the following:

(a)Where a smoke alarm is located on the ceiling it must be-(i)a minimum of 300 mm away from the corner junction of the wall and ceiling; and

(ii)between 500 mm and 1500 mm away from the high point and apexes of the ceiling, if the room has a sloping ceiling. (b) Where (a) is not possible, the smoke alarm may be installed

on the wall, and located a minimum of 300 mm and a maximum of 500 mm off the ceiling at the junction with the

Note: Exhaust Fans

Exhaust fans to comply with NCC 2022 Vol 2 Part 10.8.2 and have;

-An exhaust system installed in a kitchen, bathroom, sanitary compartment or laundry must have a minimum flow rate of (a)25 L/s for a bathroom or sanitary compartment; and (b)40 L/s for a kitchen or laundry.

-Exhaust from a kitchen, kitchen range hood, bathroom, sanitary compartment or laundry must discharge directly or via a shaft or duct to outdoor air.


Where a venting clothes dryer is installed, it must discharge directly or via a shaft or duct to outdoor air.

An exhaust system that is not run continuously and is serving a bathroom or sanitary compartment that is not ventilated in accordance with 10.6.2(a) must-


(a)be interlocked with the room's light switch; and (b)include a run-on timer so that the exhaust system continues to operate for 10 minutes after the light switch is turned off.

Preparation for future Solar Installation:

Should the solar design be required for future installation, 2/25mm solarflex (or similar) conduits marked "solar" are to be installed from the meter box to the roof space - See electrical

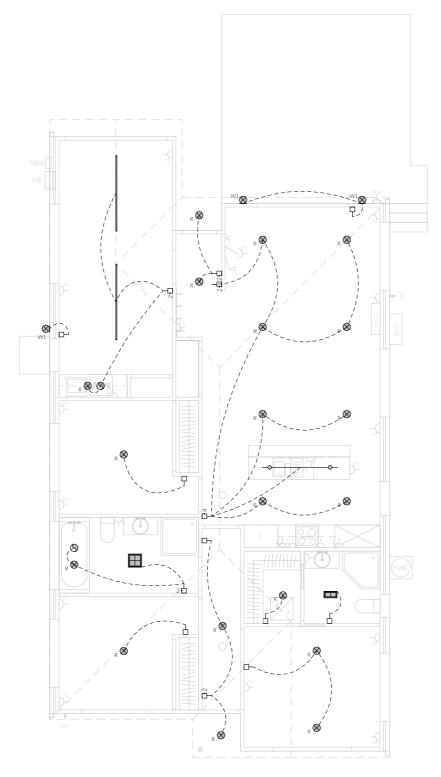

Electrical Plan - Light/Reflected Ceiling

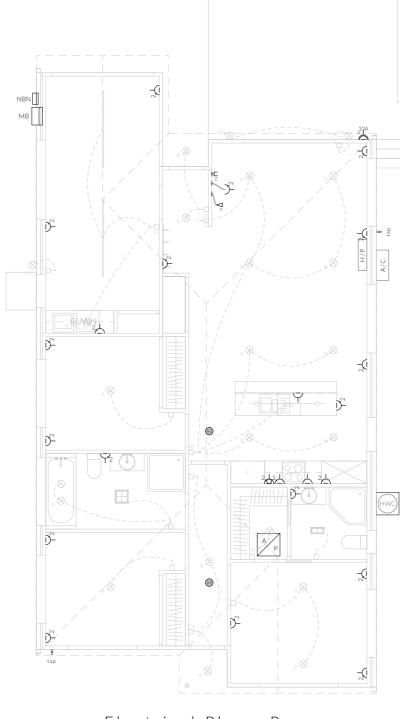

Electrical Plan - Power

Note: Lighting

Lighting layout may change, owner to confirm with builder prior to purchase/installation of exact quantity and location of electrical services provided that installation is compliant with AS3000 and artificial lighting allowances do not exceed:

5W/m² in class 1a dwellings

Approved by:

4W/m² to veranda, balcony or the like

3W/m² in a class 10a dwelling associated with the class 1a dwelling

U.N.O - All downlights are to be Insulation Contact (IC) rated.

JM

Notes

U.N.O ceilings are to be plasterboard.

--D----D - Dimmable Circuit

--т---т - Timer Circuit(as fan note)

PΒ - Plasterboard

CS - Cement Sheet Eaves

- Plywood Ceiling

-Timber Batten Ceiling

PINNACLE

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Licence: CC6073Y

U3 - Electrical Plan Revision: DA - 03

Scale: Pg. No: A2.05

Proposal: Unit Development Client: S & D Property Co Pty Ltd Address: 18 & 20 Kotona St, Rokeby 7019

25/01/2023 Drawn by: JSM/RZ Job No: 083-2023 Engineer: TBA

Building Surveyor: TBA

DA 02 27.02.2024 DA 03 04.03.2024

Site Plan, Floor Plans,



Surface Water Drainage

Ground to fall away from building in all directions in compliance with AS2870 & N.C.C 2022 3.3.3.

Surface water must be diverted away from a Class 1 building as follows:

(a)Slab-on-ground - finished ground level adjacent to a building: the external finished surface surrounding the slab must be drained to move surface water away from the building and graded to give a slope of not less than (i)25mm over the first 1m from the building

(A)in low rainfall intensity areas for surfaces that are reasonably impermeable (such as concrete or claypaving); or

(B)for any reasonably impermeable surface that forms part of an access path or ramp provided for the purposes of Clauses 1.1 (2) or (4)(c) of the ABCB Standard for Livable Housing Design; or

(ii)50 mm over the first 1 m from the building in any other case.

(b)Slab-on-ground - finished slab heights: the height of the slab-on-ground above external finished surfaces mustbe not less than

(i)100 mm above the finished ground level in low rainfall intensity areas or sandy, welldrained areas; or

(ii)50 mm above impermeable (paved or concrete) areas that slope away from the building in accordance with(a); or (iii)150 mm in any other case.

(c)The ground beneath suspended floors must be graded so that the area beneath the building is above the adjacent external finished ground level and surface water is prevented from ponding under the building.

Subsoil Drainage

is to comply with AS2870, AS3500 & N.C.C 2022

Where a subsoil drainage system is installed to divert subsurface water away from the area beneath a building, the subsoil drain must-

(a) be graded with a uniform fall of not less than 1:300: and

(b) discharge into an external silt pit or sump

(i)the level of discharge from the silt pit or sump into an impervious drainage line not less 10. than 50 mm below the invert level of the inletand provision for cleaning and maintenance.

Note

All driveway pits and grate drains to be Class B.

Stormwater pits are indicative. Location may vary depending on site conditions.

Legend

— —AG— - Ag Drain

- Stormwater Connection

Class A 300mm Stormwater Pit

X

Class B 450mm Stormwater Pit

EXISTING X-OVER FOR 18 KOTONA

STREET TO BE REMOVED, WITH

REINSTATED BY DEVELOPER AT

THE KERB AND GUTTER

EXISTING STORMWATER CONNECTION

DEVELOPERS COST

- 100mm wide trafficable grate drain


General Notes

- Remove all topsoil and organic matter from beneath concrete driveway areas and provide 100m deep compacted FCR basecourse layer.
- Concrete strength shall be 32 mpa min.
- refer detail.
- Compact concrete using mechanical
- Cure all exposed concrete surfaces by keeping moist for 7 days. i.e cover with plastic sheets.
- Connect new service connections into existing. Liaise with council's plumbing surveyor for location of existing
- All new and/or altered service connections shall be undertaken by council at the
- Provide 100ø agricultural drains at base of cut and connect to stormwater at lowest point
- Driveway to be min 100mm thick 32mpa concrete with sl82 @ 40mm cover over 100mm compacted FCR. Provide deep tooled joints or sawcut joints @ max. 4m
- Rainwater pipes to be PVC or Colorbond

- Provide control joints at 6.0 m centres-
- vibrators.
- connections.
- developer's expense.

- Driveway to be sloped to integrated kerb and gutter system on low side of driveway
- 12. Driveway sawcuts to be installed at approx. 4m centres with expansion joints at 8-12m

TYPICAL PAVEMENT DETAIL

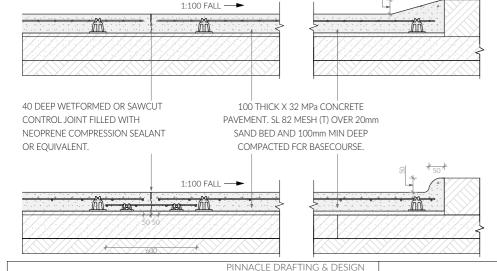

EXISTING STORMWATER CONNECTION RI · 54 11 INV: 52.34 EXISTING SW MANHOLE

3.9%FALL —

PINNACLE

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Licence: CC6073Y

Civil Plan Revision:

Approved by:

DA - 03

JM

Scale:

Pg. No:

C.01

Proposal: Unit Development 1:200 Client: S & D Property Co Pty Ltd

-05

RL: 55.47

Address: 18 & 20 Kotona St, Rokeby 7019

25/01/2023 Drawn by: JSM/RZ Job No: 083-2023 Engineer: TBA Building Surveyor: TBA

LID: 54.03 INV: TBC

> DA 02 27.02.2024 DA 03 04 03 2024

KOTONA

 \blacksquare

STREET

Site Plan, Floor Plans andscaping, Parking Ame





CROSSOVER TO BE WIDENED

LGAT STANDARD DRAWINGS

50mm KERB & GUTTER

STORMWATER LINE @ 1:100 TO EX

STORMWATER CONNECTION, WC

EXISTING STORMWATER CONNECTION

PLLIMBER

RL: 52.82 INV: 51.20


TSD-R09

TO MIN. 5.5m - CROSSOVER TO

Vehicle Movement Notes

- Movement templates demonstrate the ability of vehicles to enter intersection in a forwards direction and leave in a forwards direction.
- The base dimensions of the vehicle template represent the B85 (85th Percentile) Vehicle

- The swept path of the vehicle represent the outer extents of the vehicle.

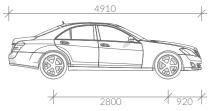

B85 Vehicle Dimensions

Width: Track: 1770 L-L Time: 5800 Turning Radius:

Parking Space requirements As defined by the Parking and Sustainable Transport Code - Table C2.3

Parking Dimensions - 90°

2600 2800 3000 3200 5400 5400 5400 5400 Width: Length: 6400 5800 5200 4800 Aisle Width:

Parking Dimensions - 45°

Width: 2600 Length: Aisle Width: 5400 3500

Parking Dimensions - Parallel

Width: 2300 Length: Aisle Width: 6700

Legend


- Solar Bollard Lighting

- Spotlight with Sensor

Turning Path Legend



- DIRECTION OF TRAVEL

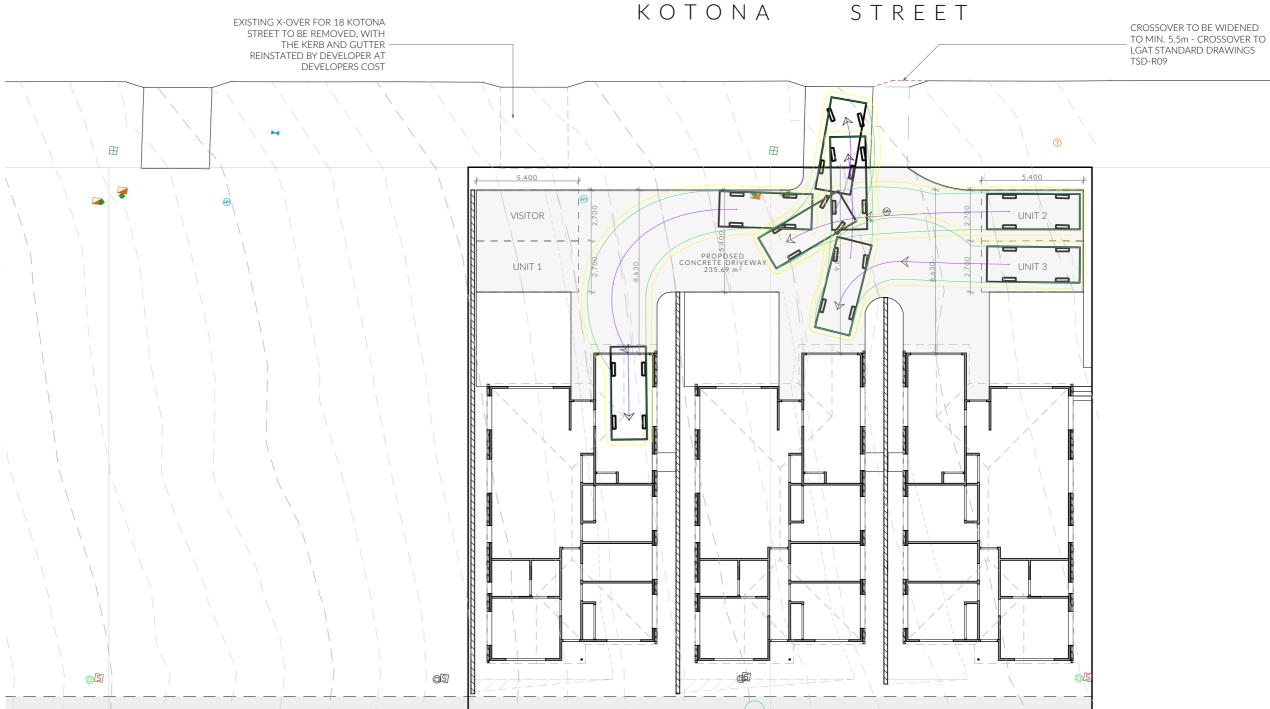



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Revision:

Approved by:

DA - 03 JM

Scale: 1:200 Pg. No: C.02

Proposal: Unit Development Client: S & D Property Co Pty Ltd Address: 18 & 20 Kotona St, Rokeby 7019

25/01/2023 Drawn by: JSM/RZ Job No: 083-2023 Engineer: TBA

Building Surveyor: TBA

ssue Date DA 02 27.02.2024 DA 03 04.03.2024

Site Plan, Floor Plans,





Vehicle Movement Notes · Movement templates demonstrate the ability of vehicles to enter intersection in a forwards direction and leave in a forwards direction. - The base dimensions of the vehicle template represent the B85 (85th Percentile) Vehicle KOTONA STREET EXISTING X-OVER FOR 18 KOTONA CROSSOVER TO BE WIDENED - The swept path of the vehicle represent the STREET TO BE REMOVED, WITH TO MIN. 5.5m - CROSSOVER TO THE KERB AND GUTTER outer extents of the vehicle. LGAT STANDARD DRAWINGS REINSTATED BY DEVELOPER AT TSD-R09 DEVELOPERS COST \blacksquare \blacksquare **B85 Vehicle Dimensions** Width: 1870 1770 Track: L-L Time: UNIT 2 5800 Turning Radius: Parking Space requirements As defined by the Parking and Sustainable Transport Code PROPOSED CONCRETE DRIVEWAY 235.69 m² UNIT 3 UNIT 1 - Table C2.3 Parking Dimensions - 90° 2600 2800 3000 3200 5400 5400 5400 5400 Width: Length: 6400 5800 5200 4800 Aisle Width: Parking Dimensions - 45° Width: 2600 Length: Aisle Width: 5400 3500 Parking Dimensions - Parallel Width: 2300 Length: 6700 Aisle Width: 3600 Legend - Solar Bollard Lighting - Spotlight with Sensor Turning Path Legend - LINE OF BODY 300mm BODY CLEARANCE - DIRECTION OF TRAVEL 05 Revision 27/02/24

PINNACLE

PINNACLE DRAFTING & DESIGN 7/3 Abernant Way, Cambridge 7170 | Parking 03 6248 4218

admin@pinnacledrafting.com.au www.pinnacledrafting.com.au Licence: CC6073Y

Revision:

Approved by:

DA - 03

JM

Scale: 1:200 Pg. No: Address: 18 & 20 Kotona St, Rokeby 7019

C.03

Proposal: Unit Development Client: S & D Property Co Pty Ltd

Date: 25/01/2023 Drawn by: JSM/RZ Job No: 083-2023 Engineer: TBA

Building Surveyor: TBA

Issue Date DA 02 27.02.2024 DA 03 04.03.2024

Site Plan, Floor Plans, Landscaping, Parking Amen





Legend - General Waste Bin Recycling Bin - Green Waste Bin KOTONA STREET EXISTING X-OVER FOR 18 KOTONA STREET TO BE REMOVED, WITH THE KERB AND GUTTER CROSSOVER TO BE WIDENED TO MIN. 5.5m - CROSSOVER TO LGAT STANDARD DRAWINGS Clothesline REINSTATED BY DEVELOPER AT - Air Conditioner unit DEVELOPERS COST - Meter Box Spk = 56.29 HWC - Hot Water Cylinder (- 1.8m to 2.1m Paling Fence 50mm DRIVEWAY KERB TO DOUBLE AS GARDEN EDGE \blacksquare \blacksquare - 1.7m high Timber Screen - 1.2m Timber Fence - Solar Bollard Lighting 50mm DRIVEWAY KERB TO DOUBLE AS GARDEN EDGE - Spotlight with Sensor -Seeded Lawn Mulched Garden Bed Gravel Area - Fine Revision 27/02/24 Decorative Pebble Note Refer to Planting Schedule & Details page for plant information. *ONLY USE FOR 3 OR MORE UNITS* **a** 05 As defined by the Parking and Sustainable Transport Code 2 plus 1 visitor per 4 dwellings No street minimum 3 + 1 visitor parking Parking Total Provided 3+1 visitor 2.1m HIGH TIMBER PALING PRIVACY FENCE FOLDING CLOTHESLINE TO BE HUNG AGAINST FENCE Impervious Areas 1023 sam Site area 390.54 sam Total Building Area 234.47 sgm Driveway Area 625.01 sgm Total Area 61.10% Impervious Free PINNACLE DRAFTING & DESIGN Issue Date DA 02 27.02.2024 25/01/2023 Description 7/3 Abernant Way, Cambridge 7170 Landscaping Plan Scale: Proposal: Unit Development Site Plan, Floor Plans, Drawn by: JSM/RZ PINNACLE 1:200 Landscaping, Parking Amend Shadow Diagrams ydenbuilders 03 6248 4218 Client: S & D Property Co Pty Ltd DA 03 04.03.2024 Job No: 083-2023 admin@pinnacledrafting.com.au Pg. No: Address: 18 & 20 Kotona St, Rokeby 7019 Engineer: TBA Revision: DA - 03 www.pinnacledrafting.com.au L.01 Building Surveyor: TBA BUILDING DESIGNERS


Document Set ID: 5210465 Version: 1, Version Date: 04/03/2024 Approved by:

Licence: CC6073Y

JM

Planting Schedule


Symbol	Element ID	Qty	Pot Size
	Eremophila sp.	13	140mm
	Hebe sp.	6	tubestock
	Lavandula sp.	5	140mm
	Melaleuca sp.	6	140mm

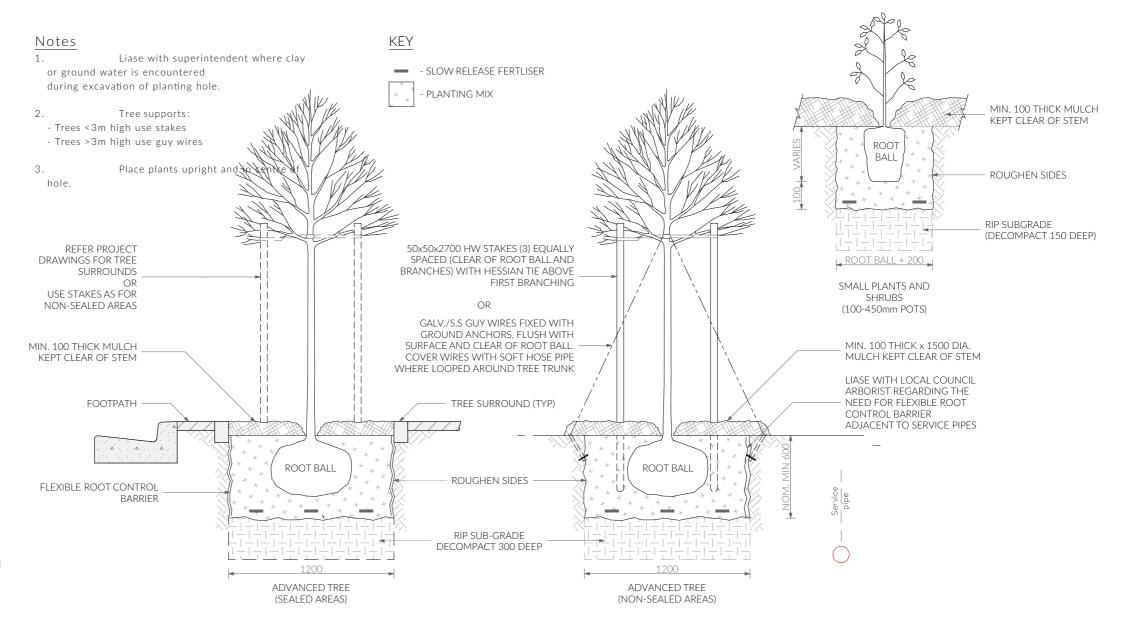

Note

Plants have been selected to be drought tolerant and low maintenance once established, it is recommended that a dripper system or similar be put into place until established. Plant locations are indicative and may be altered where suitable growing conditions cannot be met. Garden areas to be mulched with 75mm cover of selected mulch and plants are to fertilised 6 monthly or where required until established. Garden edges are to be timber, steel, or brick. Plantings that are unsuccessful will be replaced where required.

Tree and Shrub Planting

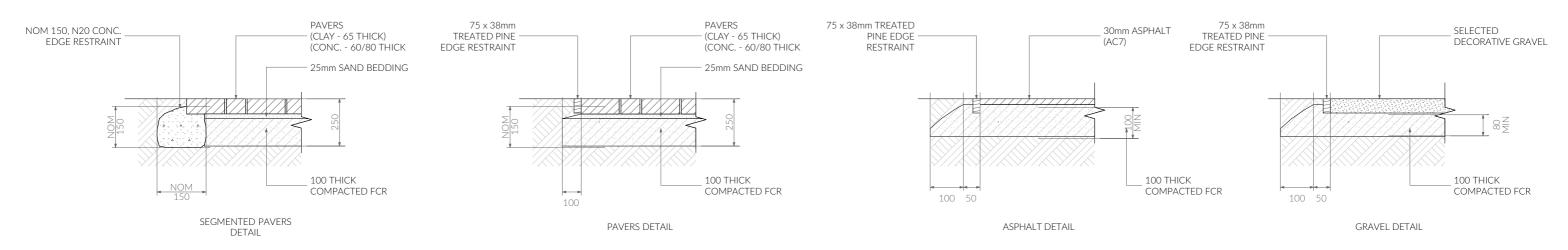

Pavement Details

NOT FOR CONSTRUCTIA:2



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Planting Schedule & Details

DA - 03

JM

Revision:

Approved by:

Scale: (9 Pg. No:

L.02

Proposal: Unit Development
Client: S & D Property Co Pty Ltd

Address: 18 & 20 Kotona St, Rokeby 7019

Date: 25/01/2023
Drawn by: JSM/RZ
Job No: 083-2023
Engineer: TBA

Building Surveyor: TBA

DA 02 27.02.2024

DA 03 04.03.2024

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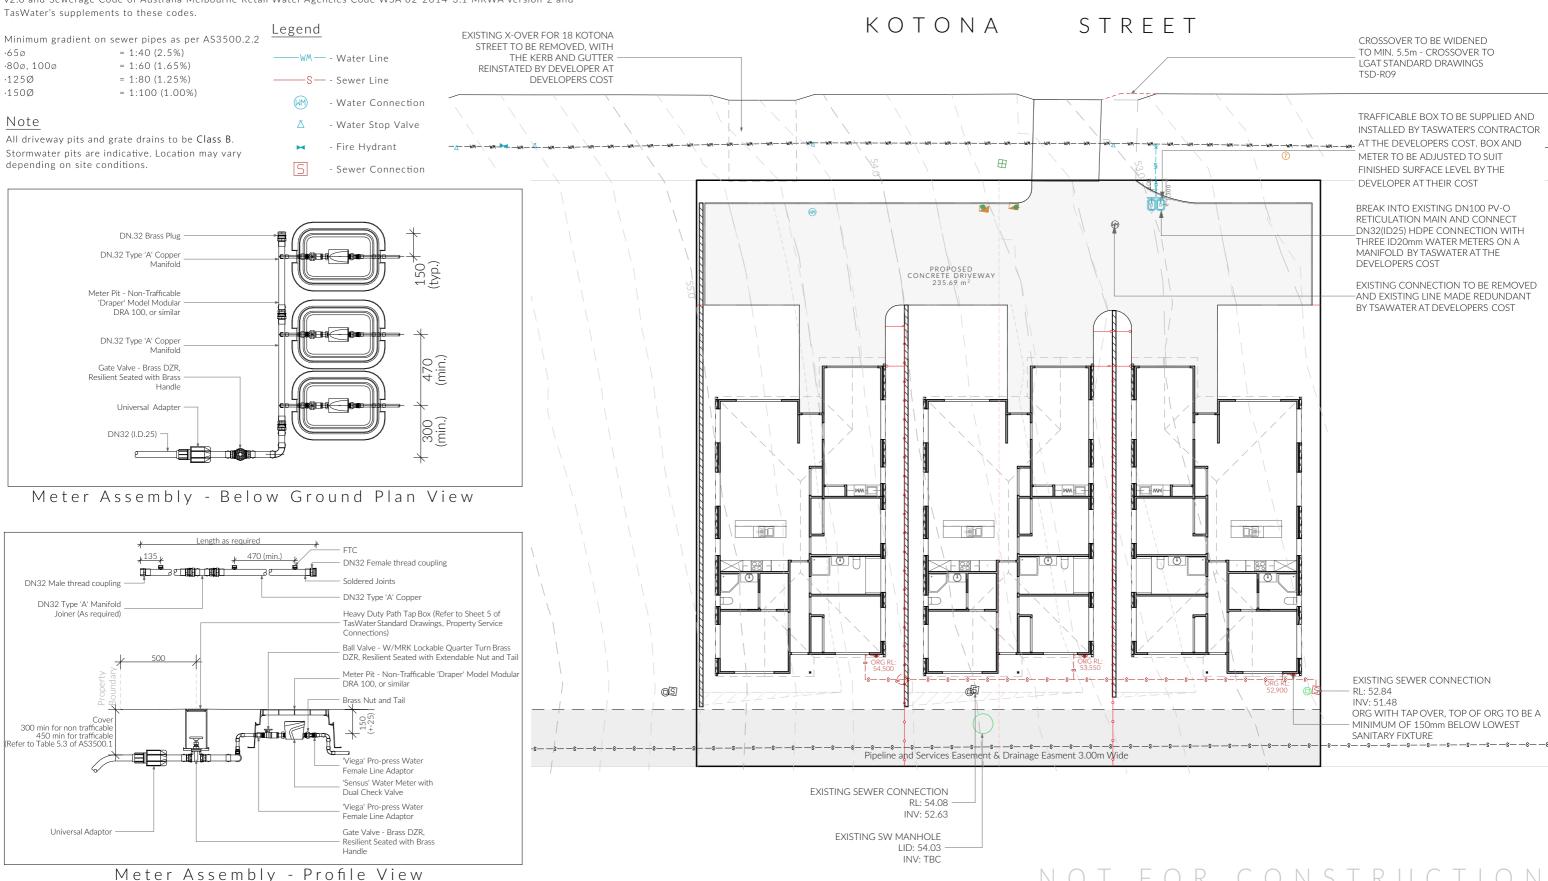


Plumbing Notes

All plumbing to be in accordance with AS3500, NCC Vol III, Tas Plumbing Code and local authority regulations.

Sewer and stormwater to mains connections, plumber to verify location on site. (refer to site plan.)

All works are to be in accordance with the water supply code of Australia WSA 03-2011-3.1 version 3.1 MRWA edition v2.0 and Sewerage Code of Australia Melbourne Retail Water Agencies Code WSA 02-2014-3.1 MRWA version 2 and TasWater's supplements to these codes



PINNACLE

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Sewer & Water Plan

Revision: DA - 03

JM

Approved by:

Scale: 1:200 @ A3 Pg. No: P.01 Proposal: Unit Development

Client: S & D Property Co Pty Ltd

Address: 18 & 20 Kotona St, Rokeby 7019

Date: 25/01/2023
Drawn by: JSM/RZ
Job No: 083-2023
Engineer: TBA
Building Surveyor: TBA

DA 02 27.02.2024

DA 03 04.03.2024

Description Site Plan, Floor Plans, Landscaping, Parking Amendments Shadow Diagrams

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